


FRONT ELEVATION

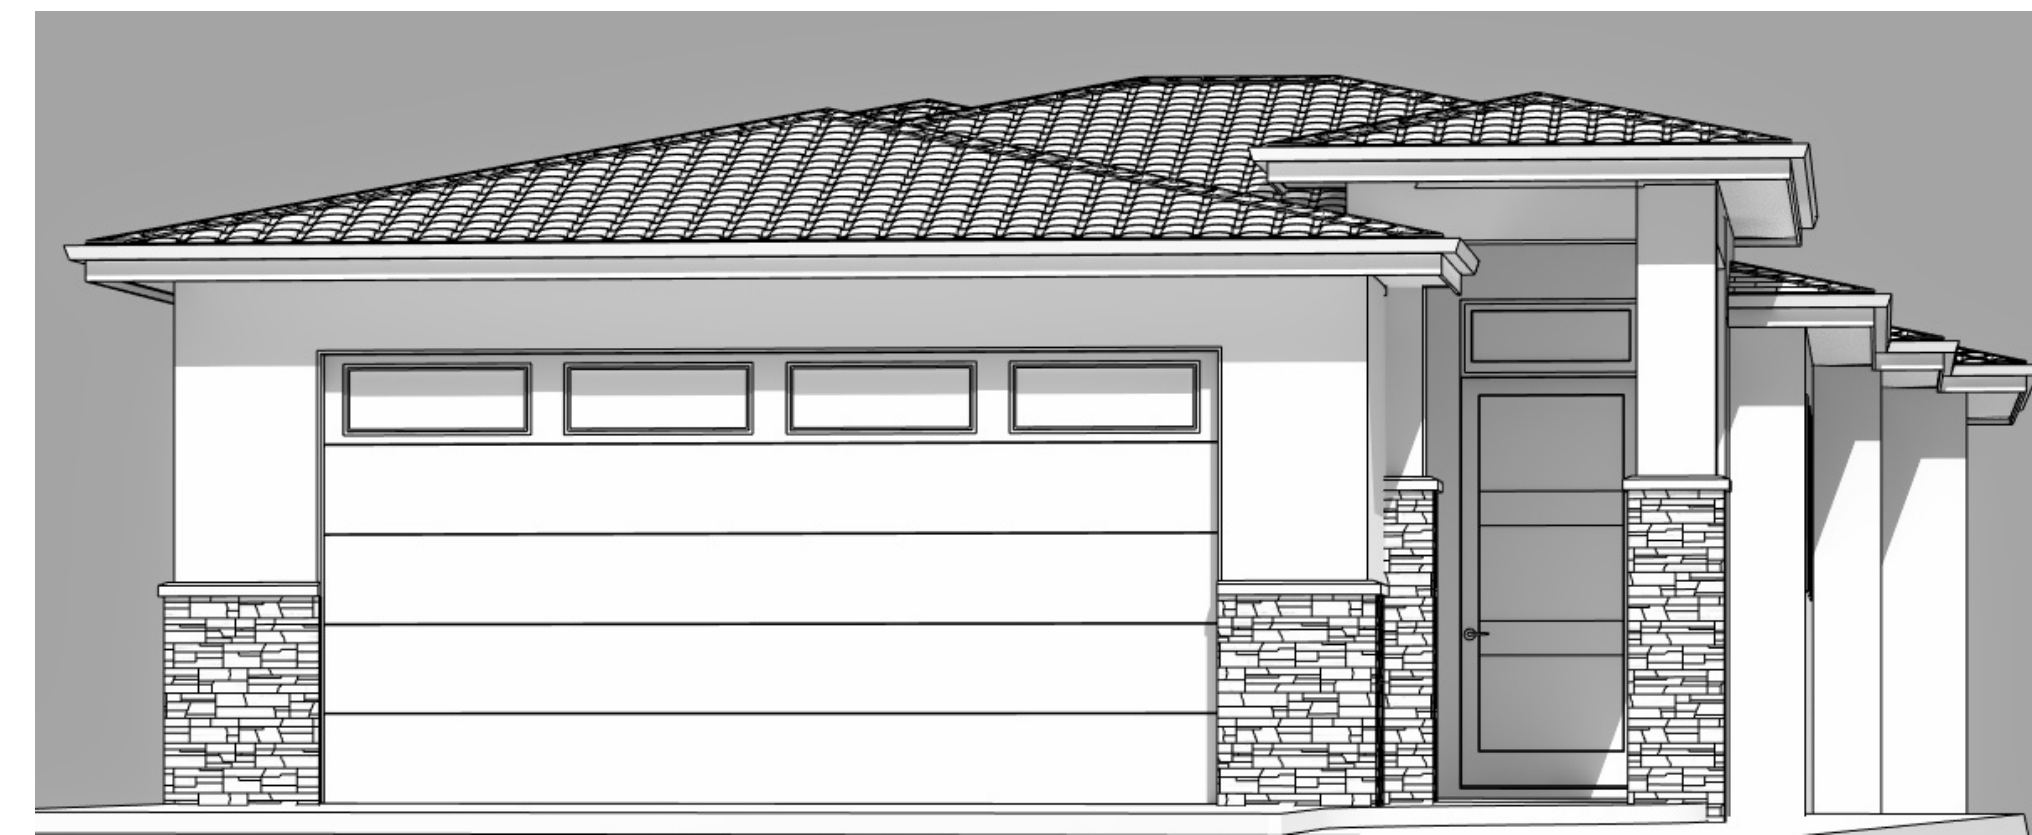

GENERAL NOTES:

THE BUILDER SHALL VERIFY THAT SITE CONDITIONS ARE CONSISTENT WITH THESE PLANS BEFORE STARTING WORK. WORK NOT SPECIFICALLY DETAILED SHALL BE CONSTRUCTED TO THE SAME QUALITY AS SIMILAR WORK THAT IS DETAILED. ALL WORK SHALL BE DONE IN ACCORDANCE WITH NATIONAL BUILDING CODE OF CANADA, B.C. BUILDING CODE AND LOCAL LAWS AND BYLAWS.

WRITTEN DIMENSIONS AND SPECIFIC NOTES SHALL TAKE PRECEDENCE OVER SCALED DIMENSIONS AND GENERAL NOTES. THE ENGINEER AND/OR DESIGNER SHALL BE CONSULTED FOR CLARIFICATION IF SITE CONDITIONS ARE ENCOUNTERED THAT ARE DIFFERENT THAN SHOWN, IF DISCREPANCIES ARE FOUND IN THE PLANS OR NOTES, OR IF A QUESTION ARISES OVER THE INTENT OF THE PLANS OR NOTES. CONTRACTOR SHALL VERIFY AND IS RESPONSIBLE FOR ALL DIMENSIONS (INCLUDING ROUGH OPENINGS).

WINDOWS SPECIFICATIONS TO BE CONFIRMED BY OWNER/BUILDER PRIOR ORDERING TO ENSURE PROPER VENTING AND EGRESS.

PLEASE SEE ADDITIONAL NOTES CALLED OUT ON OTHER SHEETS.

BUILDING PERFORMANCE:

HEAT LOSS CALCULATIONS SHALL COMPLY WITH THE REQUIREMENTS OF REGIONAL AND LOCAL CODES. SEE CALCULATIONS. PORCHES, DECKS, FOUNDATION, FIREPLACE ENCLOSURES, AND GARAGE AREAS NOT INCLUDED IN LIVING AREA. ALL EXHAUST FANS TO BE VENTED DIRECTLY TO THE EXTERIOR. ALL PENETRATIONS OF THE BUILDING ENVELOPE SHALL BE SEALED WITH CAULK OR FOAM.

GENERAL NOTES:

ALL WORK SHALL BE IN ACCORDANCE WITH THE BC BUILDING CODE AND ALL LOCAL LAWS AND BYLAWS.

IT IS THE RESPONSIBILITY OF THE BUILDING CONTRACTOR TO REVIEW AND VERIFY ALL DIMENSIONS, SPECS AND CONNECTIONS BEFORE CONSTRUCTION BEGINS. FURTHERMORE, IT IS THE CONTRACTORS RESPONSIBILITY FOR THE CORRECT SITING OF THE BUILDING TO CONFORM WITH NECESSARY SETBACKS, EASEMENTS, AND COVENANTS.

INARTIFEX DESIGN LTD. WILL NOT BE LIABLE FOR ANY ERRORS OR OMISSIONS.

FINISH NOTES:

RENDERINGS ARE NOT TO SCALE; ALL RENDERINGS ARE FOR ARTISTIC DEPICTION ONLY. PLAN UPDATES MAY NOT BE REFLECTED IN RENDERINGS. RENDERINGS SHALL NOT BE USED FOR CONSTRUCTION.

FINAL FINISHES SHALL BE CONFIRMED WITH THE HOME OWNER/BUILDER PRIOR TO APPLICATION.

GRADING NOTES:

- 1 CONTRACTOR TO VERIFY LOCATION OF ALL EXISTING UTILITIES.
- 2 PROVIDE POSITIVE DRAINAGE AWAY FROM BUILDING.
- 3 FINAL GRADE TO CONVEY SURFACE DRAINAGE TOWARD ROCK CHANNELS AND DISPERSION TRENCHES.

HRV: TO BE CONSTRUCTED WITH HRV

THIS HOME TO BE BUILT TO ENERGY STEP CODE 3

*REFER TO CERTIFIED ENERGY ADVISOR'S REPORT

BUILDING CONTRACTOR/HOME OWNER TO REVIEW AND VERIFY ALL DIMENSIONS, SPECS, AND CONNECTIONS BEFORE CONSTRUCTION BEGINS.

WINDOW SPECIFICATIONS TO BE CONFIRMED BY CONTRACTOR/HOME OWNER PRIOR ORDERING TO ENSURE CORRECT EGRESS AND VENTING

PROVIDE PROPER SLOPE TO ALLOW DRAINAGE AWAY FROM RESIDENCE

Proposed Project For:

LOT 22 (883)

1677 HARBOUR VIEW CRES. WEST KELOWNA

WEST HARBOUR

Sheet Title:

FRONT & RIGHT ELEVATIONS


DATE:

2025-01-30

SCALE: 1/4" = 1'-0" (UNLESS OTHERWISE NOTED)

SHEET NO.:

1/8

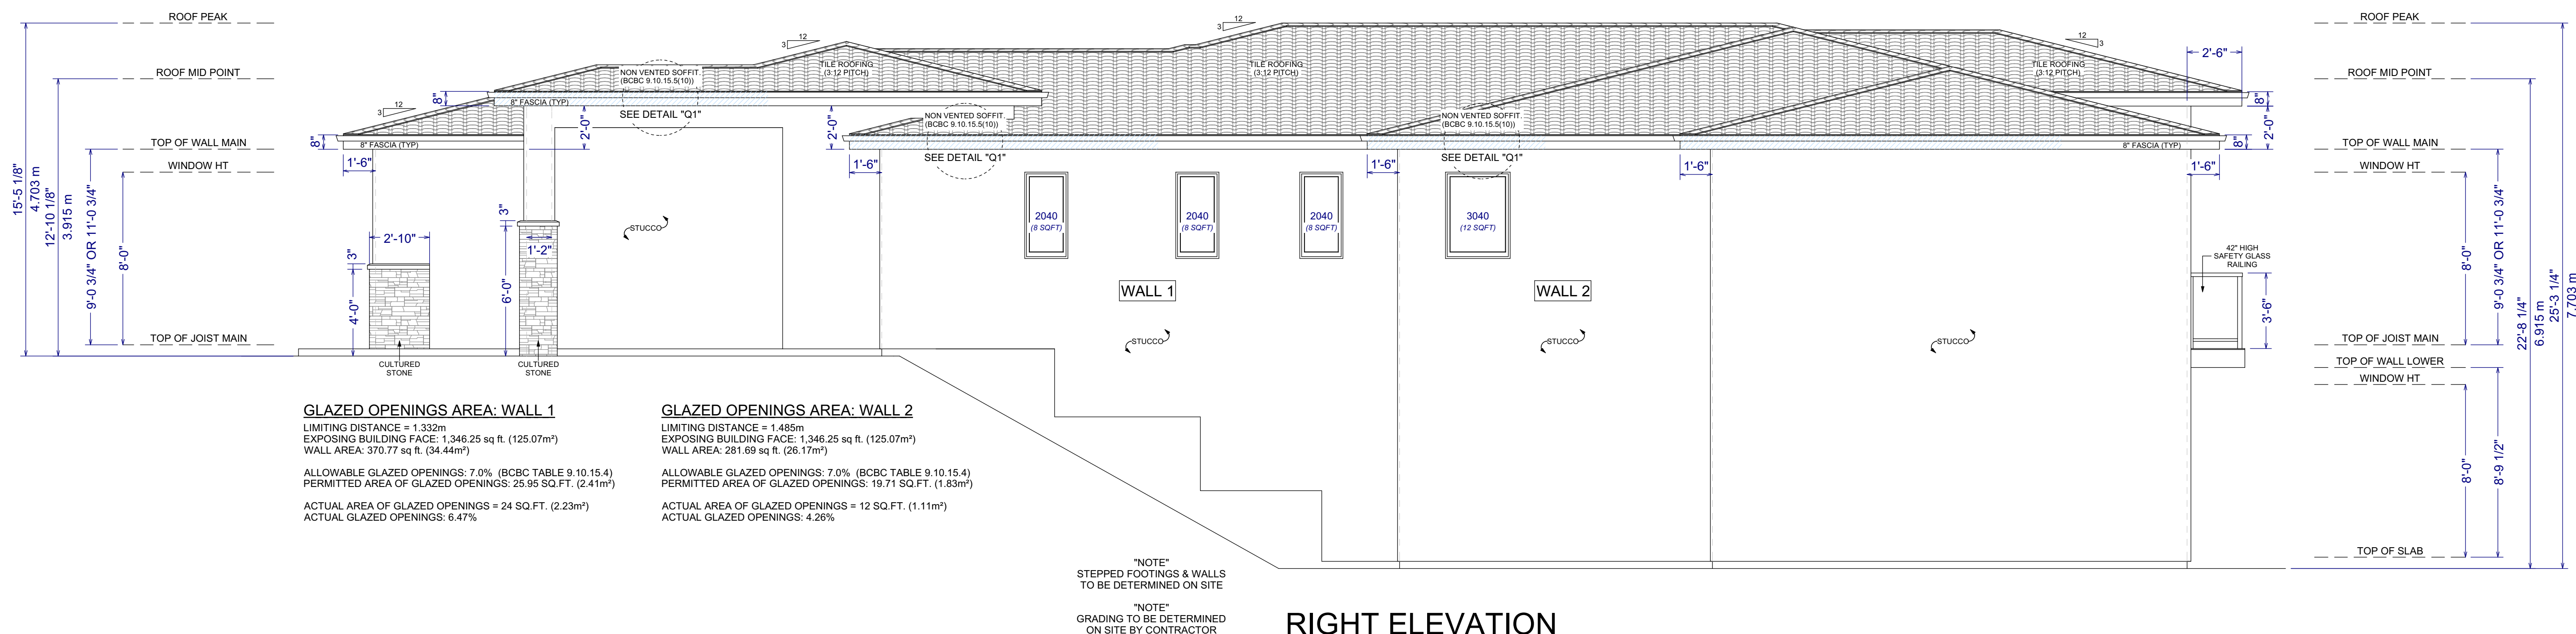

RIGHT ELEVATION



REAR ELEVATION



GRADING NOTES:

- 1 CONTRACTOR TO VERIFY LOCATION OF ALL EXISTING UTILITIES.
- 2 PROVIDE POSITIVE DRAINAGE AWAY FROM BUILDING.
- 3 FINAL GRADE TO CONVEY SURFACE DRAINAGE TOWARD ROCK CHANNELS AND DISPERSION TRENCHES.

FINISH NOTES:


RENDERINGS ARE NOT TO SCALE; ALL RENDERINGS ARE FOR ARTISTIC DEPICTION ONLY. PLAN UPDATES MAY NOT BE REFLECTED IN RENDERINGS. RENDERINGS SHALL NOT BE USED FOR CONSTRUCTION.

FINAL FINISHES SHALL BE CONFIRMED WITH THE HOME OWNER/BUILDER PRIOR TO APPLICATION

BUILDING CONTRACTOR/HOME OWNER TO REVIEW AND VERIFY ALL DIMENSIONS, SPECS, AND CONNECTIONS BEFORE CONSTRUCTION BEGINS.

WINDOW SPECIFICATIONS TO BE CONFIRMED BY CONTRACTOR/HOME OWNER PRIOR ORDERING TO ENSURE CORRECT EGRESS AND VENTING

PROVIDE PROPER SLOPE TO ALLOW DRAINAGE AWAY FROM RESIDENCE

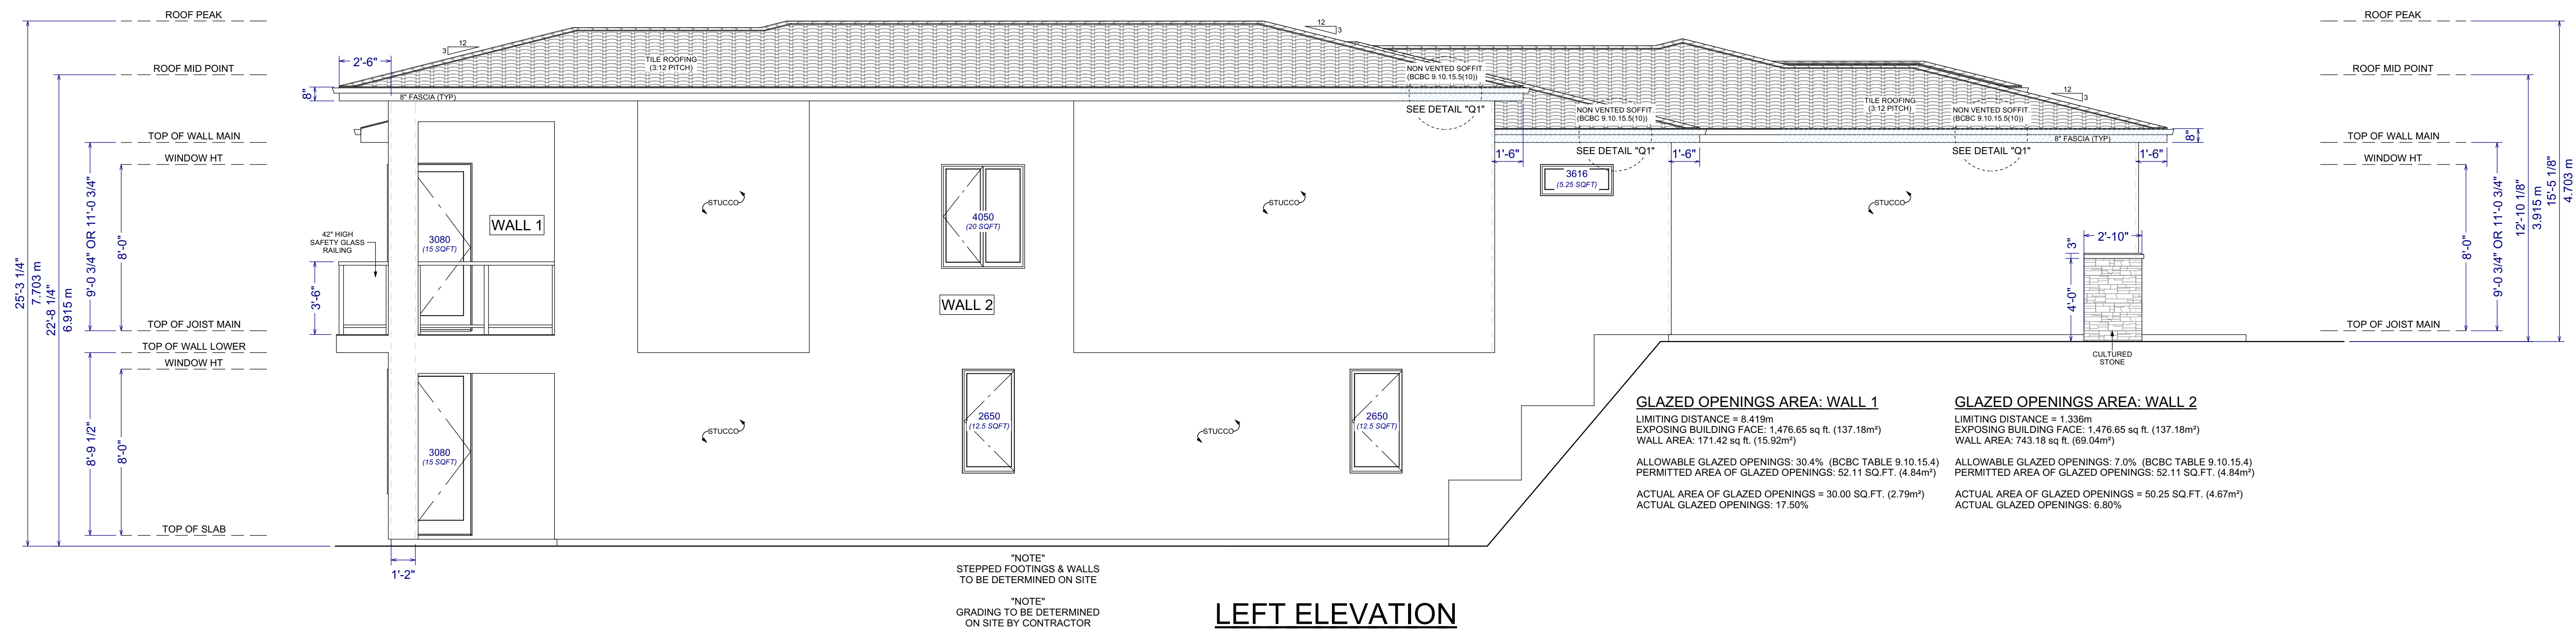

GLAZED OPENINGS AREA: WALL 1

LIMITING DISTANCE = 8.419m
 EXPOSING BUILDING FACE: 1,476.65 sq ft. (137.18m²)
 WALL AREA: 171.42 sq ft. (15.92m²)
 ALLOWABLE GLAZED OPENINGS: 30.4% (BCBC TABLE 9.10.15.4)
 PERMITTED AREA OF GLAZED OPENINGS: 52.11 SQ.FT. (4.84m²)
 ACTUAL AREA OF GLAZED OPENINGS = 30.00 SQ.FT. (2.79m²)
 ACTUAL GLAZED OPENINGS: 17.50%


GLAZED OPENINGS AREA: WALL 2

LIMITING DISTANCE = 1.336m
 EXPOSING BUILDING FACE: 1,476.65 sq ft. (137.18m²)
 WALL AREA: 743.18 sq ft. (69.04m²)
 ALLOWABLE GLAZED OPENINGS: 7.0% (BCBC TABLE 9.10.15.4)
 PERMITTED AREA OF GLAZED OPENINGS: 52.11 SQ.FT. (4.84m²)
 ACTUAL AREA OF GLAZED OPENINGS = 50.25 SQ.FT. (4.67m²)
 ACTUAL GLAZED OPENINGS: 6.80%

"NOTE"
 STEPPED FOOTINGS & WALLS
 TO BE DETERMINED ON SITE

"NOTE"
 GRADING TO BE DETERMINED
 ON SITE BY CONTRACTOR

LEFT ELEVATION

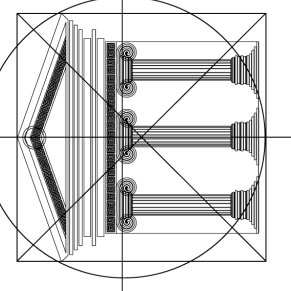

Proposed
 Project For:

LOT 22 (883)

1677 HARBOUR
 VIEW CRES.
 WEST KELOWNA

WEST HARBOUR

Sheet Title:

REAR & LEFT
 ELEVATIONS


DATE:

2025-01-30

SCALE: 1/4" = 1'-0"
 (UNLESS OTHERWISE NOTED)

SHEET NO.:

2/8

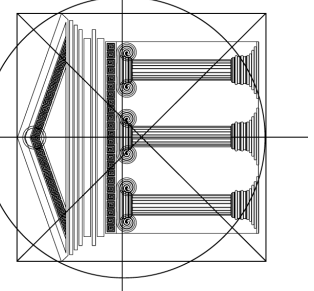

WALL LEGEND	
	8" CONC. FNDTN. WALL
	8" CONC. FNDTN. WALL 2x6" INTERIOR WALL
	ICF FNDTN. WALL
	2x6" EXTERIOR WALL FINISH ON BOTH SIDES
	2x4" EXTERIOR WALL FINISH ON BOTH SIDES
	2x4 EXT. WALL
	2x6 EXT. WALL
	2x6 INT. WALL
	2x4 INT. WALL
	FIRE RATED WALL 2x6 STUDS @ 16" O/C 1/2" TYPE "X" DRYWALL R20 INSULATION
	2x6 BEARING WALL
	2x4 BEARING WALL

GENERAL NOTES:
 -VENTILATION AS PER BCBC 9.32
 -WINDOWS/DOORS REQUIRE NAFS LABEL
 -APPROVED SMOKE ALARM DETECTORS TO BE INSTALLED AND INTERCONNECTED

RADON VENT PIPE:

- 1) MIN. 100MM DIAMETER
- 2) TO TERMINATE MIN:
 A) 1.0M ABOVE ANY AIR INLET, DOOR OR OPENABLE WINDOW.
 B) 2.0M ABOVE A ROOF THAT SUPPORTS AN OCCUPANCY
 C) 3.5M IN ANY OTHER DIRECTION
 D) 1.8M FROM PROPERTY LINE
- 3) LABEL "RADON VENT PIPE" AT EVERY 1.2M AND AT EVERY CHANGE IN DIRECTION

BUILDING CONTRACTOR/HOME OWNER TO REVIEW AND VERIFY ALL DIMENSIONS, SPECS, AND CONNECTIONS BEFORE CONSTRUCTION BEGINS.


WINDOW SPECIFICATIONS TO BE CONFIRMED BY CONTRACTOR/HOME OWNER PRIOR ORDERING TO ENSURE CORRECT EGRESS AND VENTING

PROVIDE PROPER SLOPE TO ALLOW DRAINAGE AWAY FROM RESIDENCE

LOWER LEVEL:
 LIVING AREA: 1,449 SQFT.
 (NOT INCLUDING STORAGE/MECH & STAIRS)

UNLESS NOTED:
 WINDOW LINTELS @ 8'-0"
 WALL HEIGHT 8'-9 1/2"

NOTE: DRAINAGE PER GEOTECH

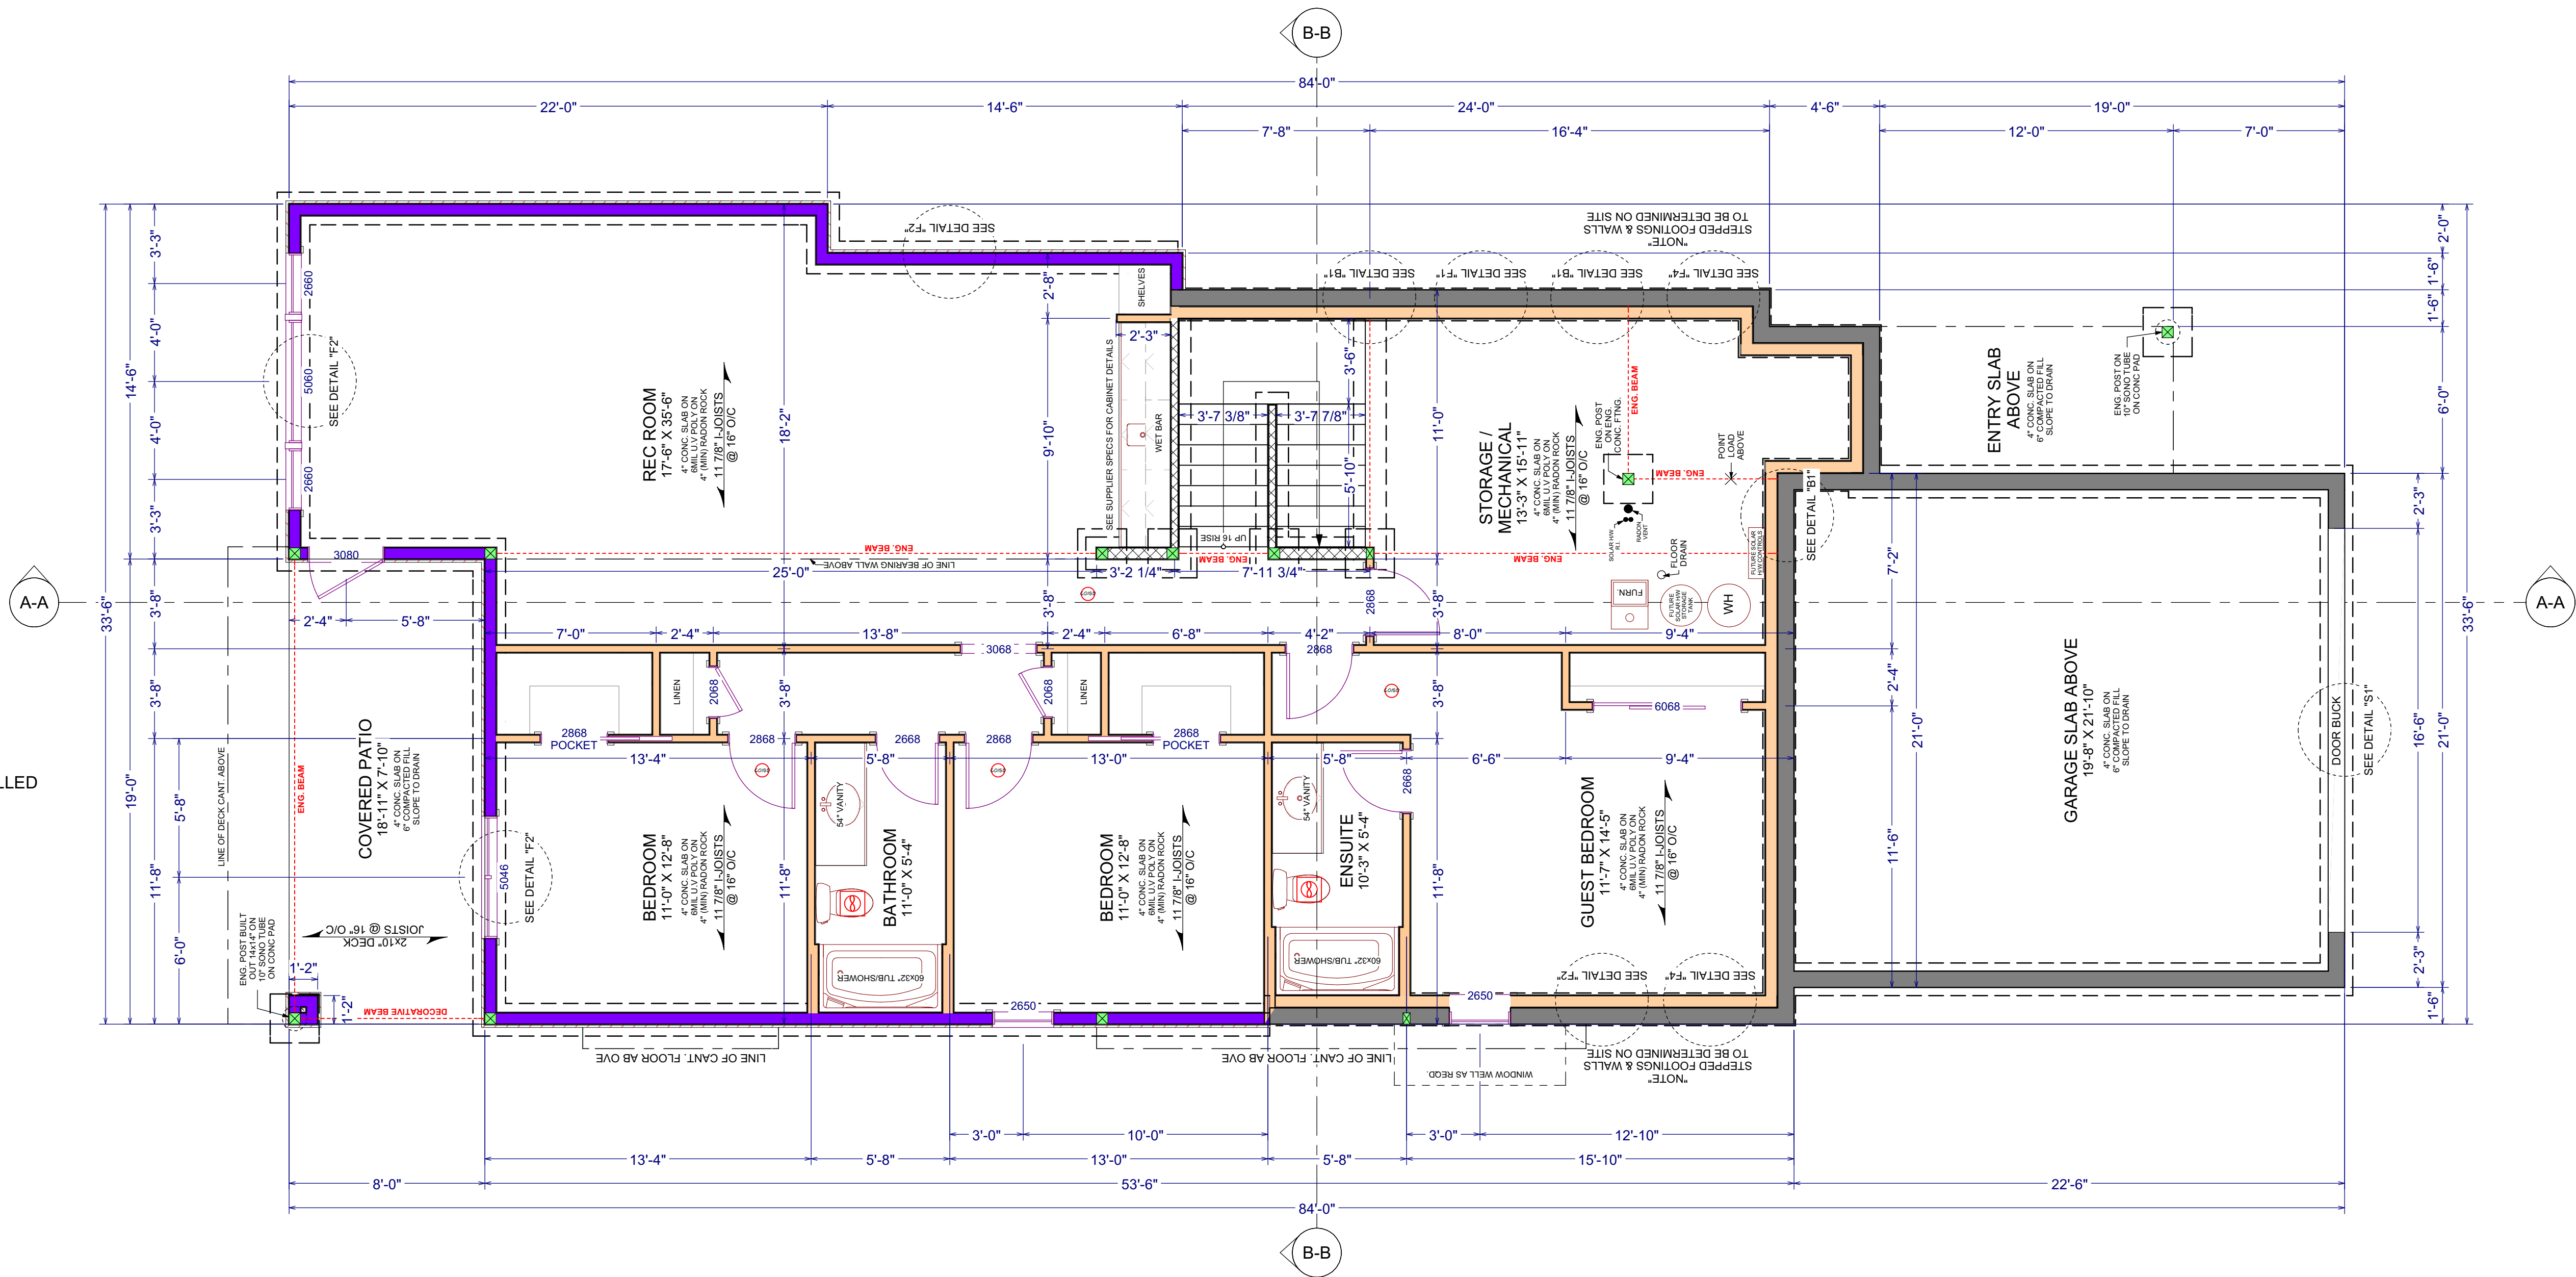

Proposed Project For:

LOT 22 (883)

1677 HARBOUR VIEW CRES.
 WEST KELOWNA

WEST HARBOUR

Sheet Title:

LOWER LEVEL FLOOR PLAN


DATE:

2025-01-30

SCALE: 1/4" = 1'-0"
 (UNLESS OTHERWISE NOTED)

SHEET NO.:

3/8

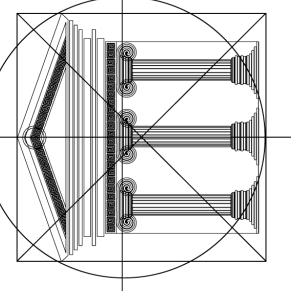

WALL LEGEND	
	8" CONC. FNDTN. WALL
	8" CONC. FNDTN. WALL 2x6" INTERIOR WALL
	ICF FNDTN. WALL
	2x6" EXTERIOR WALL FINISH ON BOTH SIDES
	2x4" EXTERIOR WALL FINISH ON BOTH SIDES
	2x4 EXT. WALL
	2x6 EXT. WALL
	2x6 INT. WALL
	2x4 INT. WALL
	FIRE RATED WALL 2x6 STUDS @ 16" O/C 1/2" TYPE "X" DRYWALL R20 INSULATION
	2x6 BEARING WALL
	2x4 BEARING WALL

GENERAL NOTES:
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 -WINDOWS/DOORS REQUIRE NAFS LABEL
 -APPROVED SMOKE ALARM DETECTORS TO BE INSTALLED AND INTERCONNECTED

RADON VENT PIPE:
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 B) 2.0M ABOVE A ROOF THAT SUPPORTS AN OCCUPANCY
 C) 3.5M IN ANY OTHER DIRECTION
 D) 1.8M FROM PROPERTY LINE
 3) LABEL "RADON VENT PIPE" AT EVERY 1.2M AND AT EVERY CHANGE IN DIRECTION

BUILDING CONTRACTOR/HOME OWNER TO REVIEW AND VERIFY ALL DIMENSIONS, SPECS, AND CONNECTIONS BEFORE CONSTRUCTION BEGINS.

WINDOW SPECIFICATIONS TO BE CONFIRMED BY CONTRACTOR/HOME OWNER PRIOR ORDERING TO ENSURE CORRECT EGRESS AND VENTING


PROVIDE PROPER SLOPE TO ALLOW DRAINAGE AWAY FROM RESIDENCE

MAIN LEVEL:
 LIVING AREA: 1,834 SQFT.
 (NOT INCLUDING GARAGE)

TOTAL LIVING AREA: 3,283 SQ.FT.

UNLESS NOTED:
 WINDOW LINTELS @ 8'-0"
 WALL HEIGHT 9' -0 3/4"

NOTE: DRAINAGE PER GEOTECH

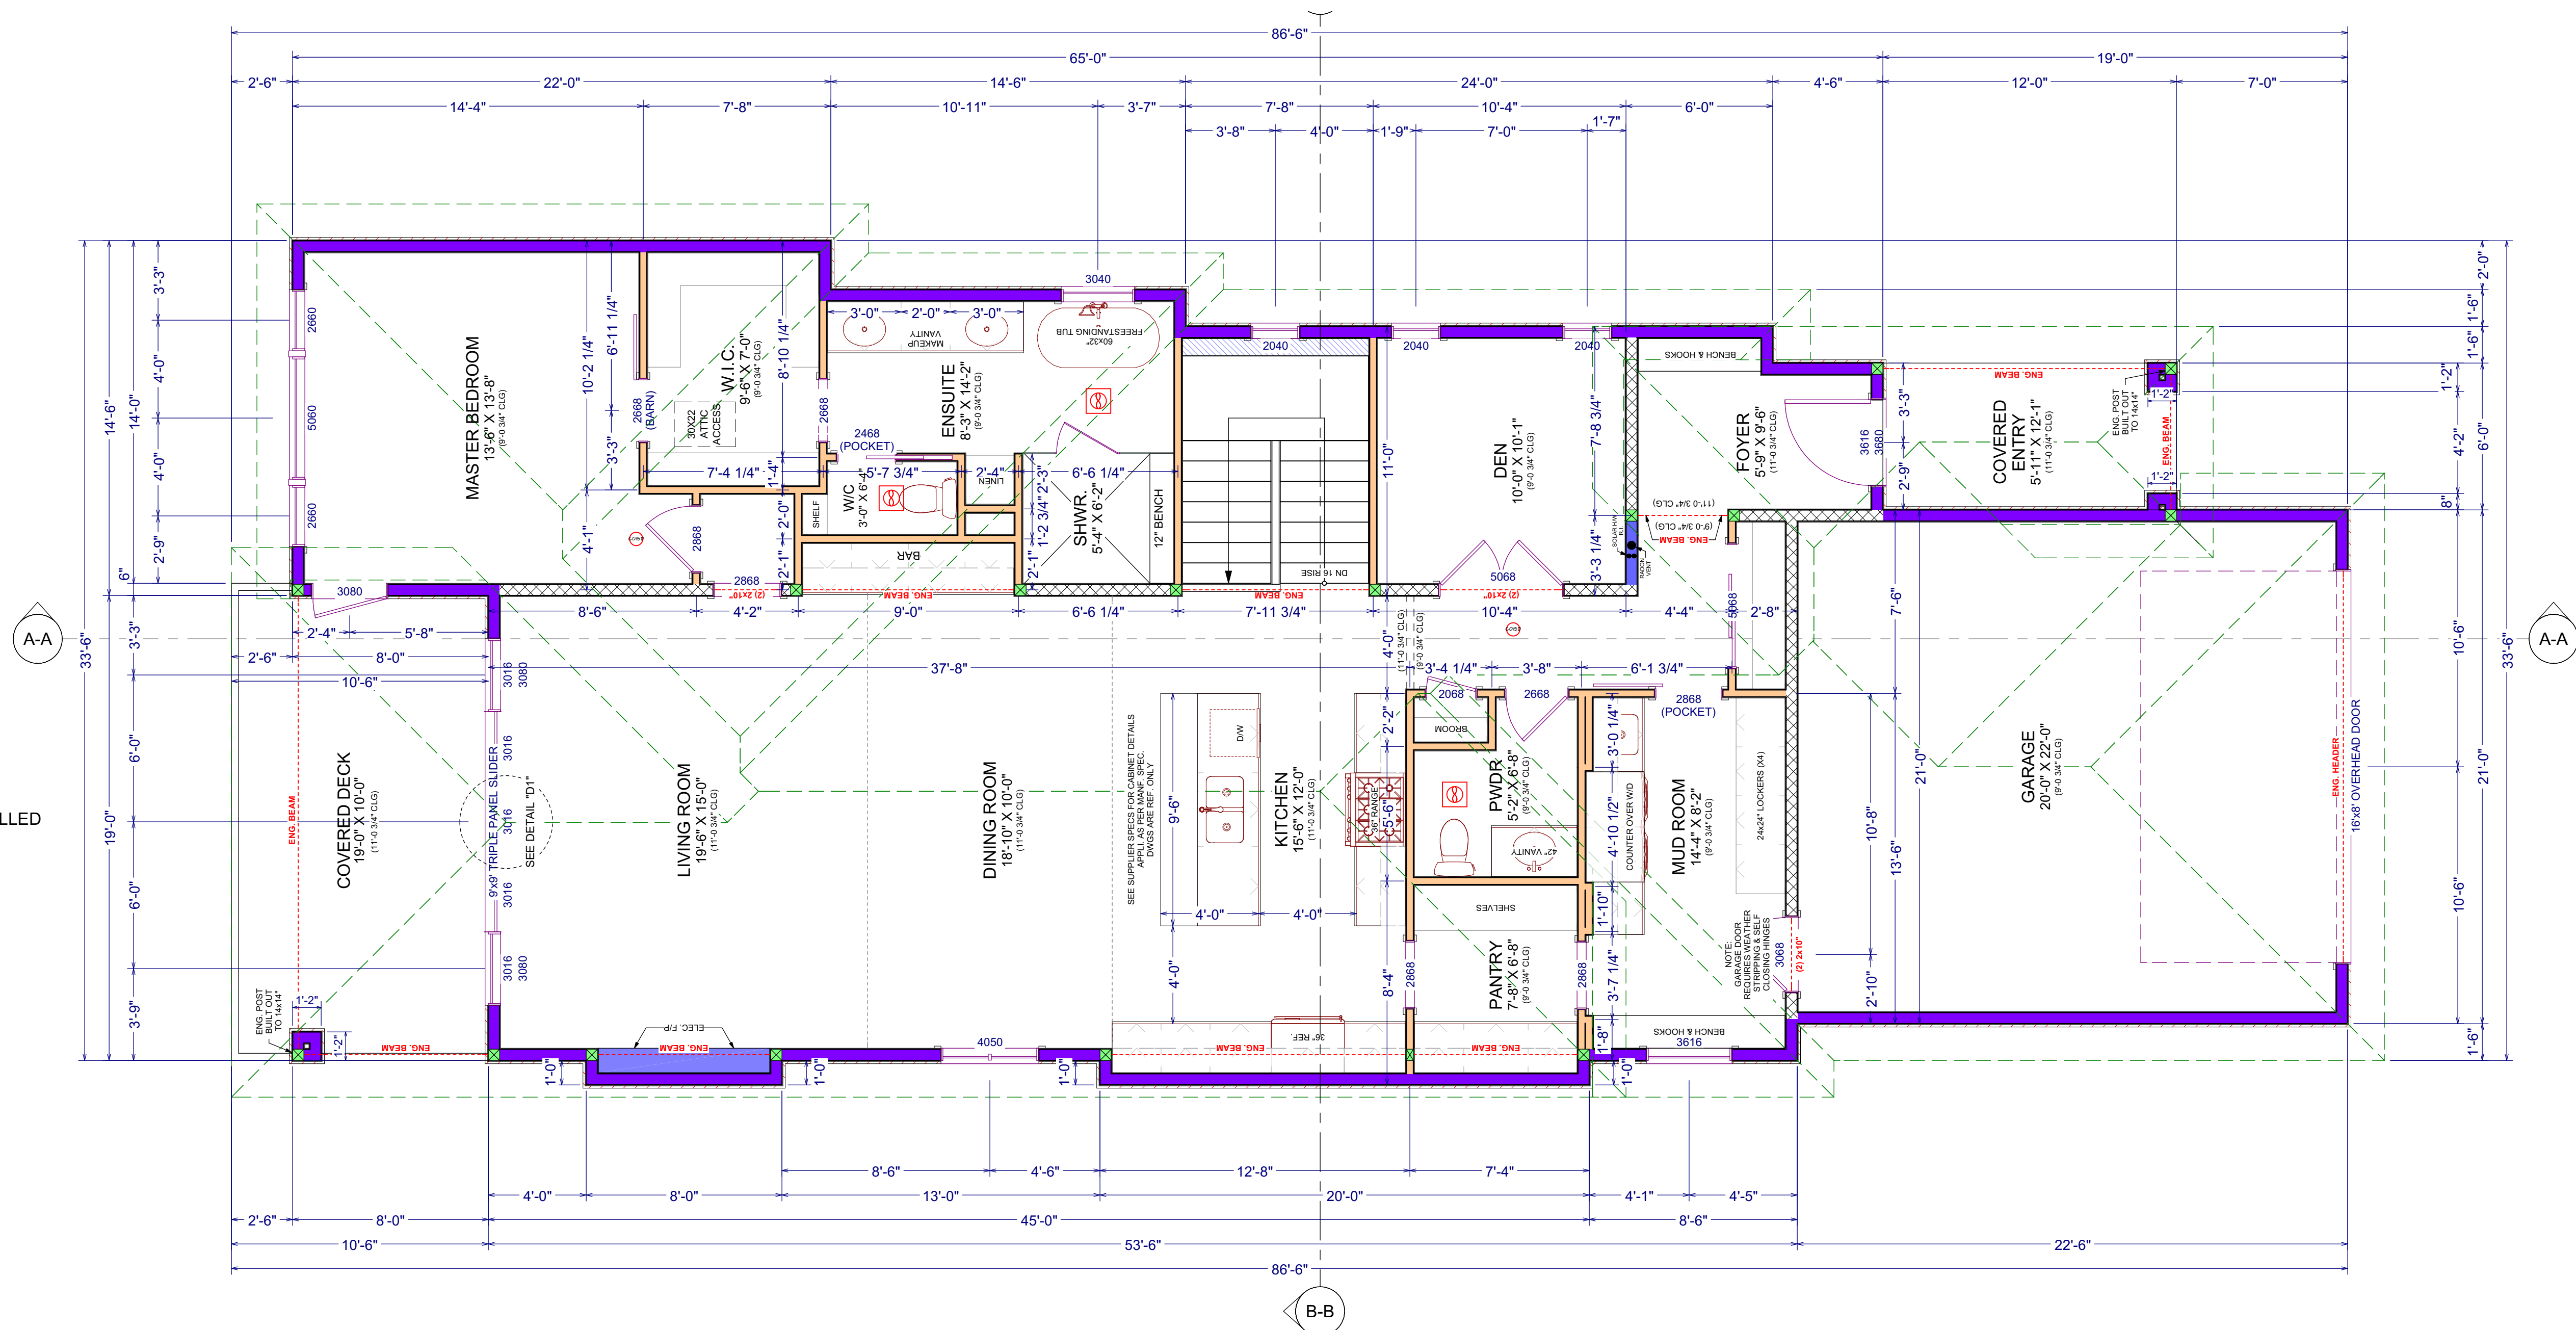

Proposed Project For:

LOT 22 (883)

1677 HARBOUR VIEW CRES.
 WEST KELOWNA

WEST HARBOUR

Sheet Title:

MAIN LEVEL FLOOR PLAN


DATE:

2025-01-30

SCALE: 1/4" = 1'-0"
 (UNLESS OTHERWISE NOTED)

SHEET NO.:

4/8

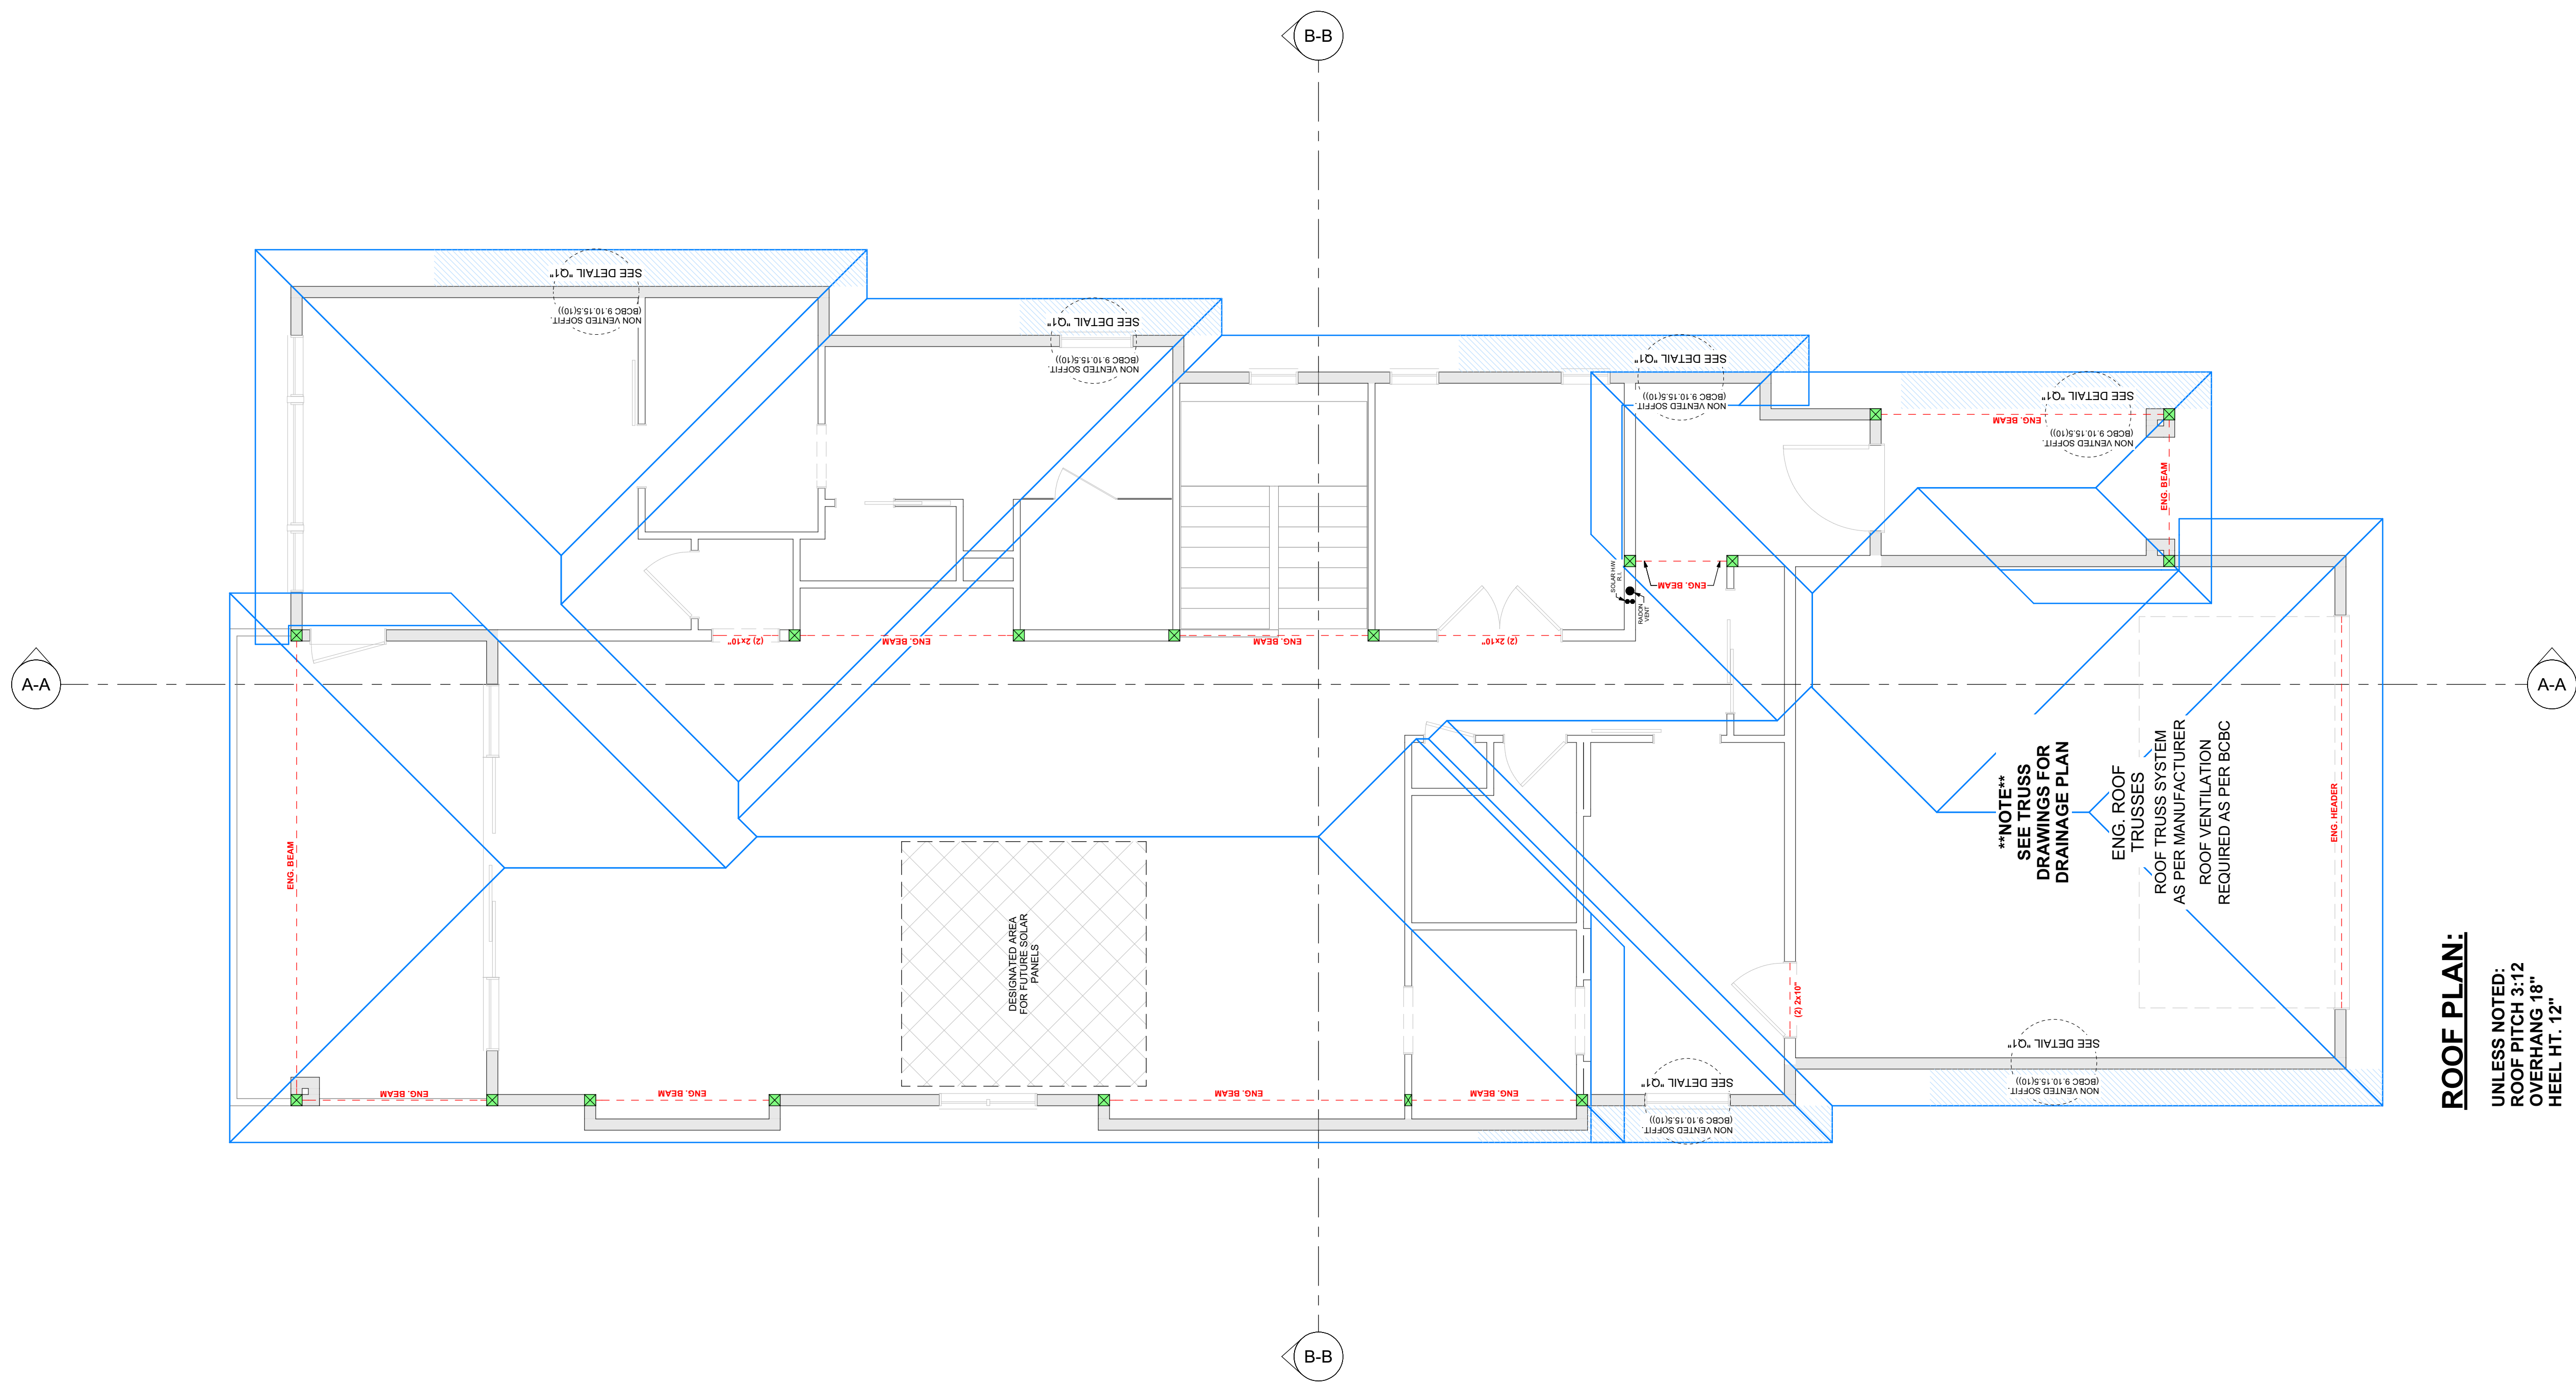

ROOF PLAN:

UNLESS NOTED:
 ROOF PITCH 3:12
 OVERHANG 18"
 HEEL HT. 12"

****NOTE**
 SEE TRUSS
 DRAWINGS FOR
 DRAINAGE PLAN**

ENG. ROOF
 TRUSSES
 ROOF TRUSS SYSTEM
 AS PER MANUFACTURER
 ROOF VENTILATION
 REQUIRED AS PER BCBC

Proposed
 Project For:



LOT 22 (883)
 1677 HARBOUR
 VIEW CRES.
 WEST KELOWNA
 WEST HARBOUR

Sheet Title:
 ROOF PLAN

DATE:
 2025-01-30

SCALE: 1/4" = 1'-0"
 (UNLESS OTHERWISE NOTED)

SHEET NO.:
5/8

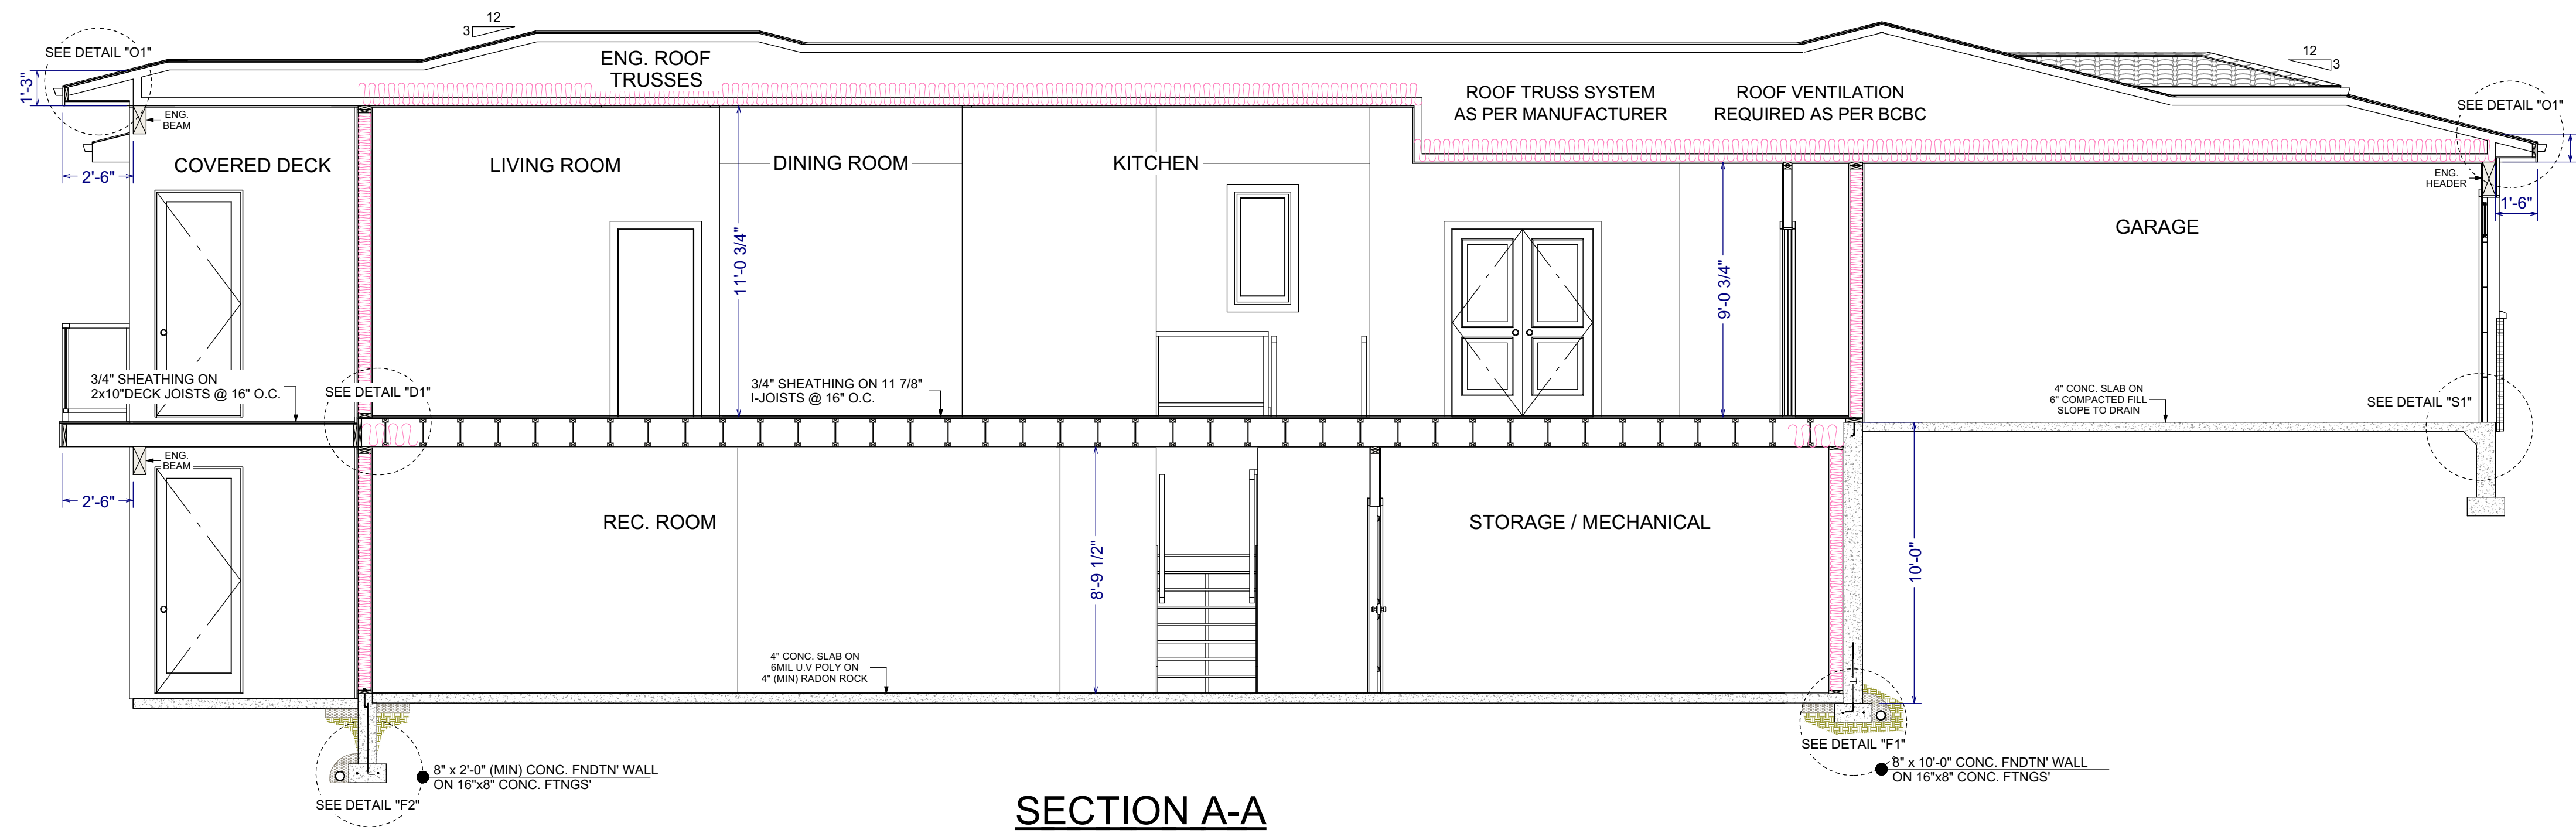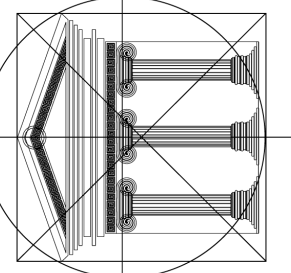

SECTION A-A

GENERAL NOTES:

ALL WORK SHALL BE IN ACCORDANCE WITH THE BC BUILDING CODE AND ALL LOCAL LAWS AND BYLAWS.

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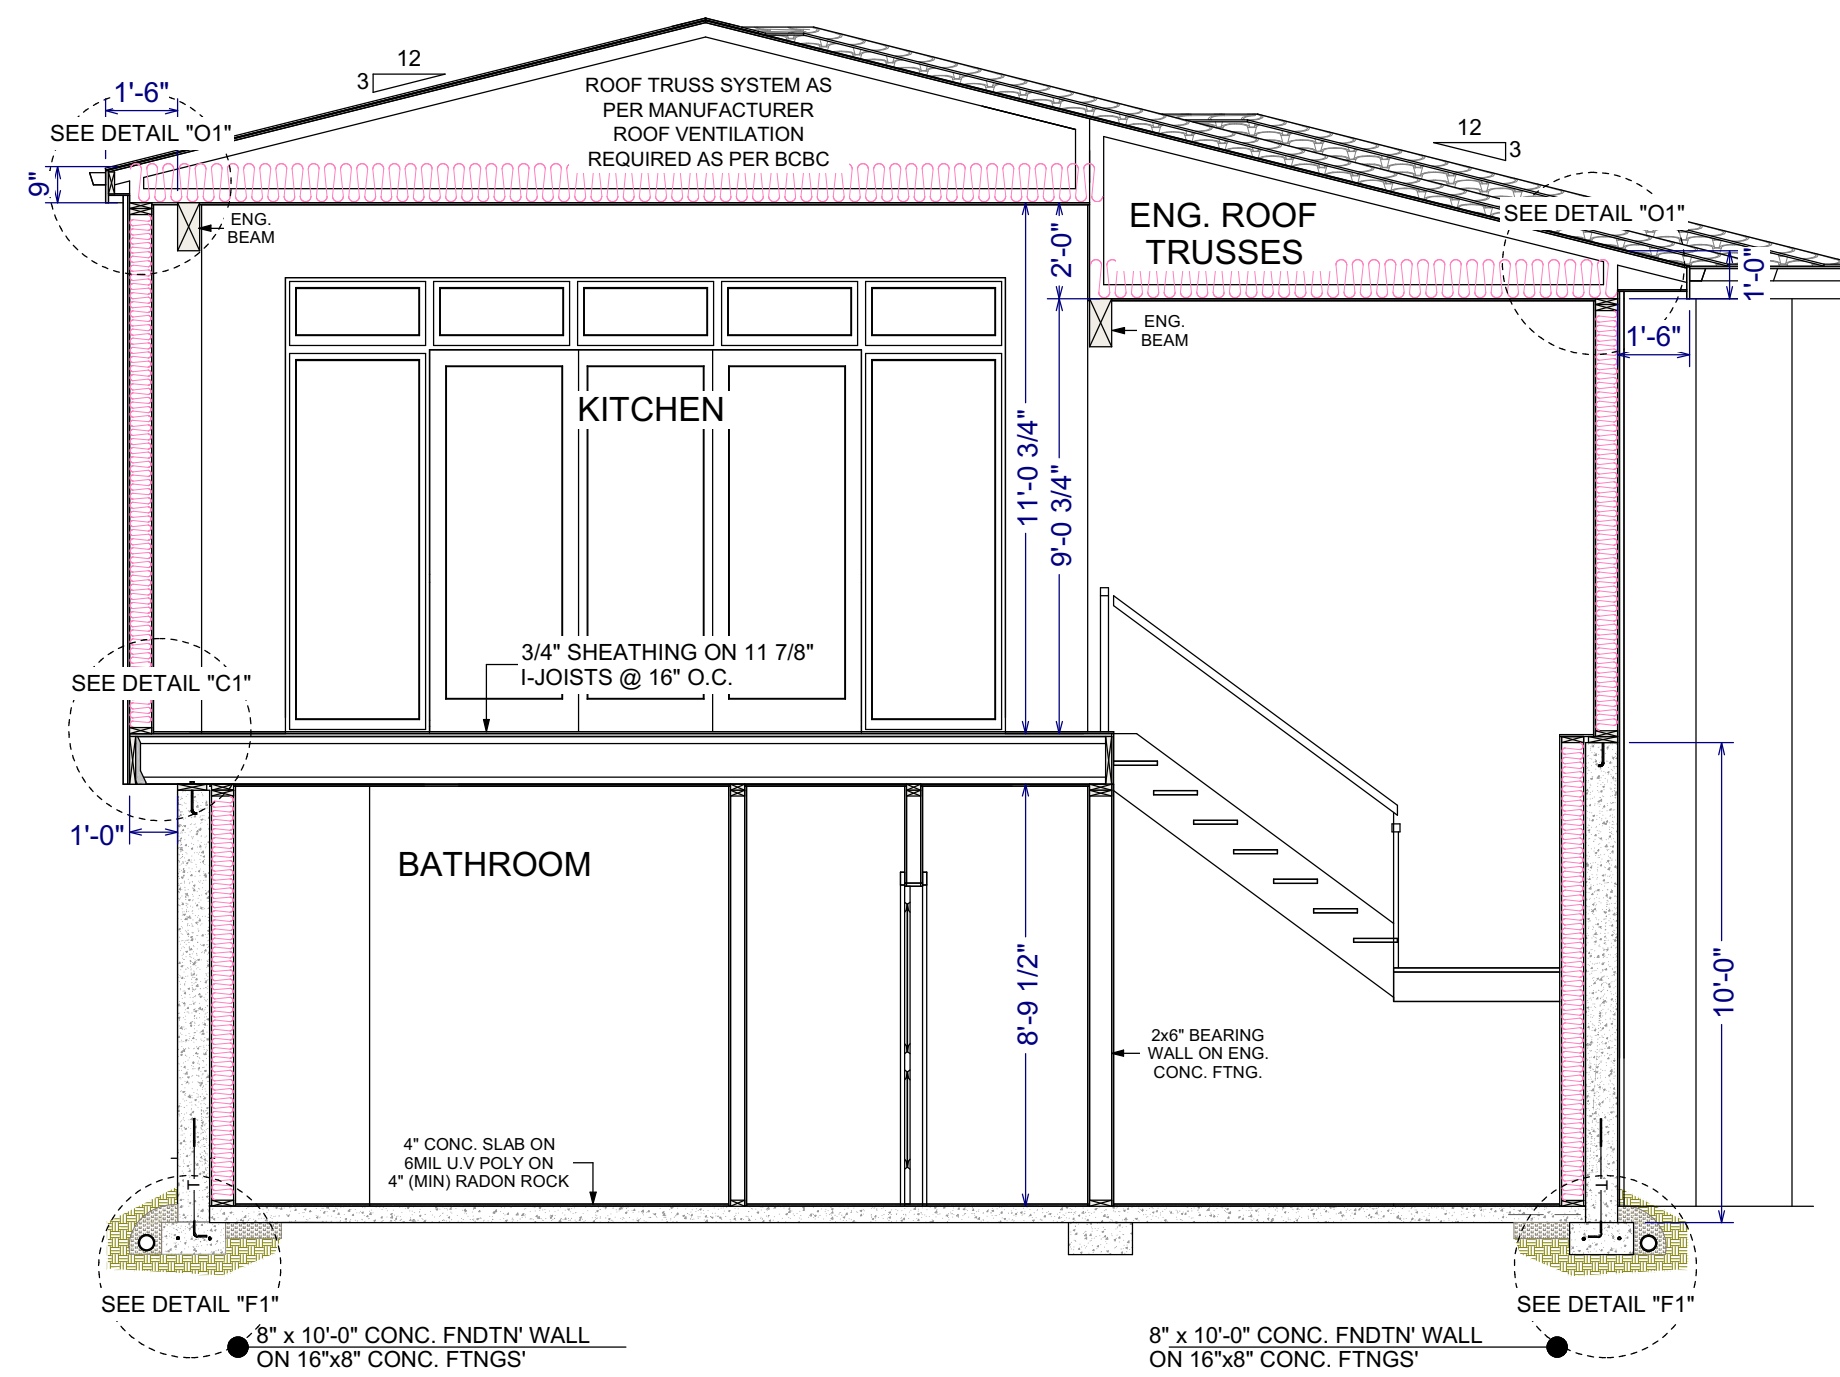
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BUILDING CONTRACTOR/HOME OWNER TO REVIEW AND VERIFY ALL DIMENSIONS, SPECS, AND CONNECTIONS BEFORE CONSTRUCTION BEGINS.

WINDOW SPECIFICATIONS TO BE CONFIRMED BY CONTRACTOR/HOME OWNER PRIOR ORDERING TO ENSURE CORRECT EGRESS AND VENTING

PROVIDE PROPER SLOPE TO ALLOW DRAINAGE AWAY FROM RESIDENCE



SECTION B-B

Proposed Project For:

LOT 22 (883)

1677 HARBOUR VIEW CRES.
WEST KELOWNA

WEST HARBOUR

Sheet Title:

CROSS SECTIONS

DATE:



2025-01-30

SCALE: 1/4" = 1'-0"
(UNLESS OTHERWISE NOTED)

SHEET NO.:

6/8

OLD FERRY WHARF ROAD

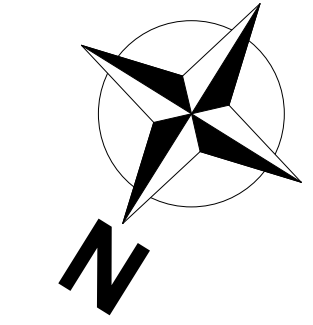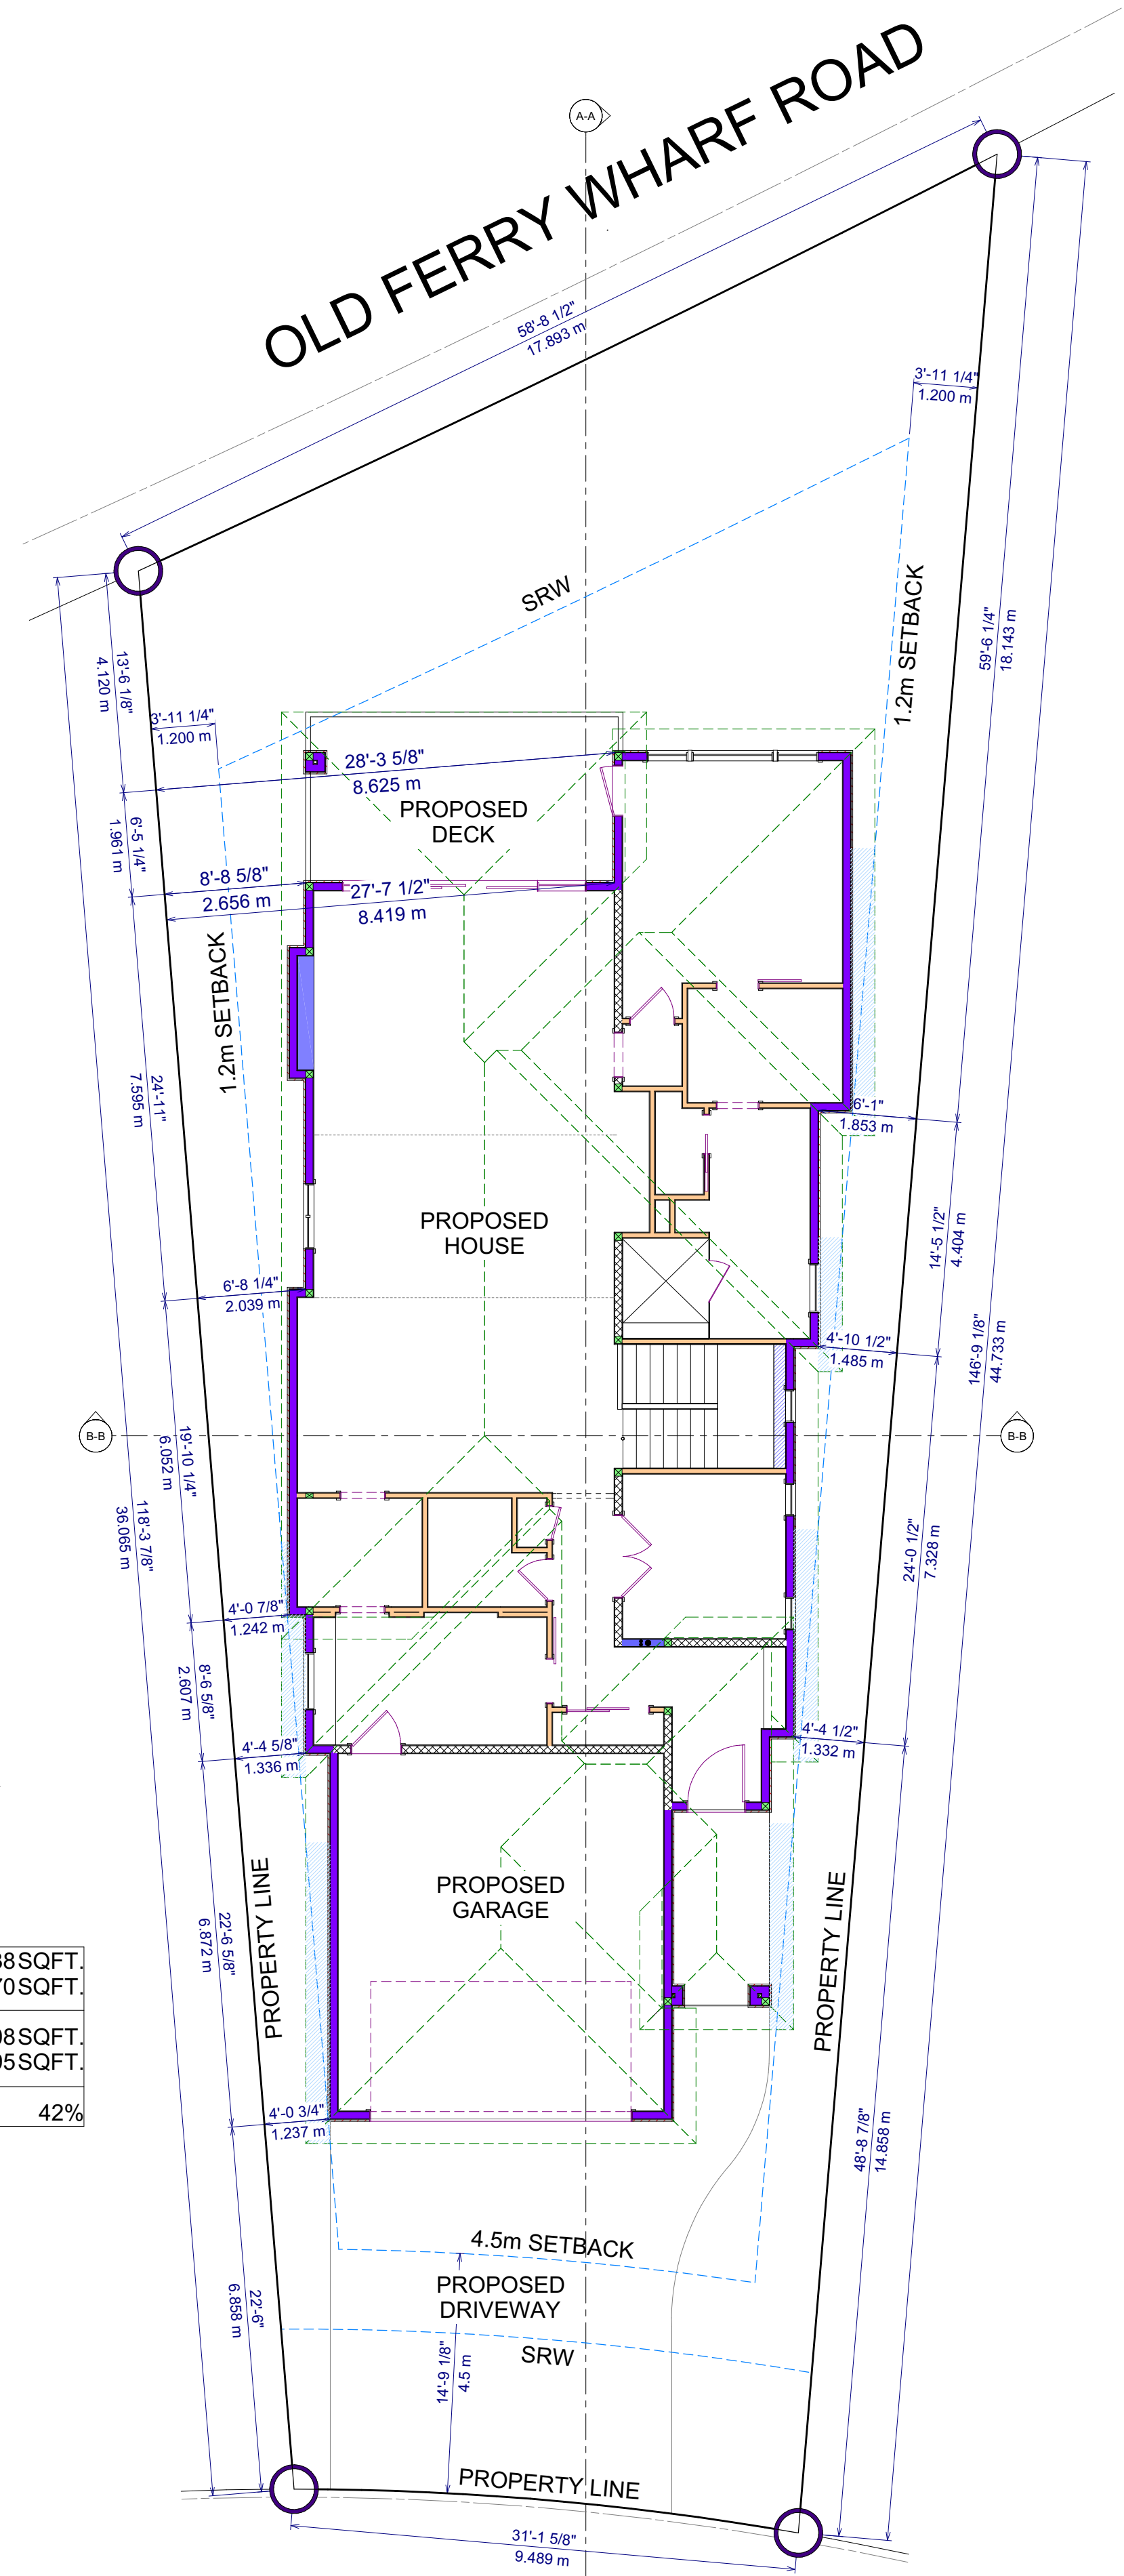

LOT 22
510.5m²


SCALE: 1/8" = 1'-0"

- GRADING NOTES:**
1. CONTRACTOR TO VERIFY LOCATION OF ALL EXISTING UTILITIES.
 2. PROVIDE POSITIVE DRAINAGE AWAY FROM BUILDING.
 3. FINAL GRADE TO CONVEY SURFACE DRAINAGE TOWARD ROCK CHANNELS AND DISPERSION TRENCHES.

MAIN FLOOR:	1,838 SQFT.
GARAGE:	470 SQFT.
TOTAL FOOTPRINT:	2,308 SQFT.
LOT AREA:	5,495 SQFT.
TOTAL COVERAGE:	42%

HARBOUR VIEW CRESCENT


BUILDING CONTRACTOR/HOME OWNER TO REVIEW AND VERIFY ALL DIMENSIONS, SPECS, AND CONNECTIONS BEFORE CONSTRUCTION BEGINS.

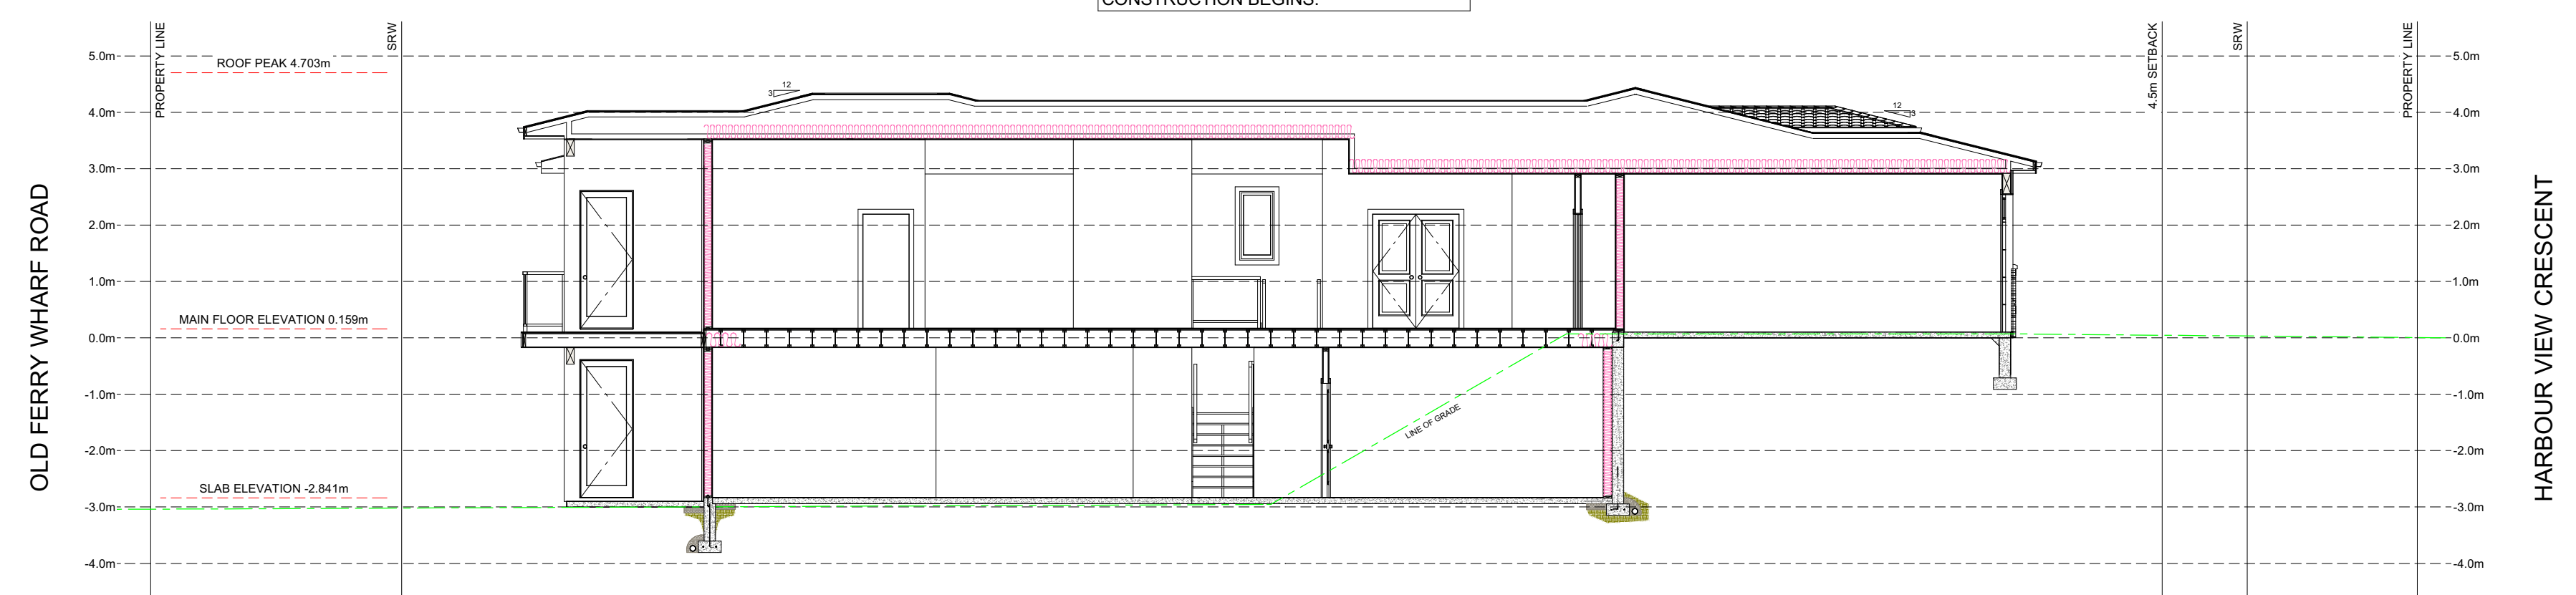

SITE SECTION A-A
SCALE: 1/8" = 1'-0"


- GRADING NOTES:**
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 2. PROVIDE POSITIVE DRAINAGE AWAY FROM BUILDING.
 3. FINAL GRADE TO CONVEY SURFACE DRAINAGE TOWARD ROCK CHANNELS AND DISPERSION TRENCHES.

BUILDING CONTRACTOR/HOME OWNER TO REVIEW AND VERIFY ALL DIMENSIONS, SPECS, AND CONNECTIONS BEFORE CONSTRUCTION BEGINS.

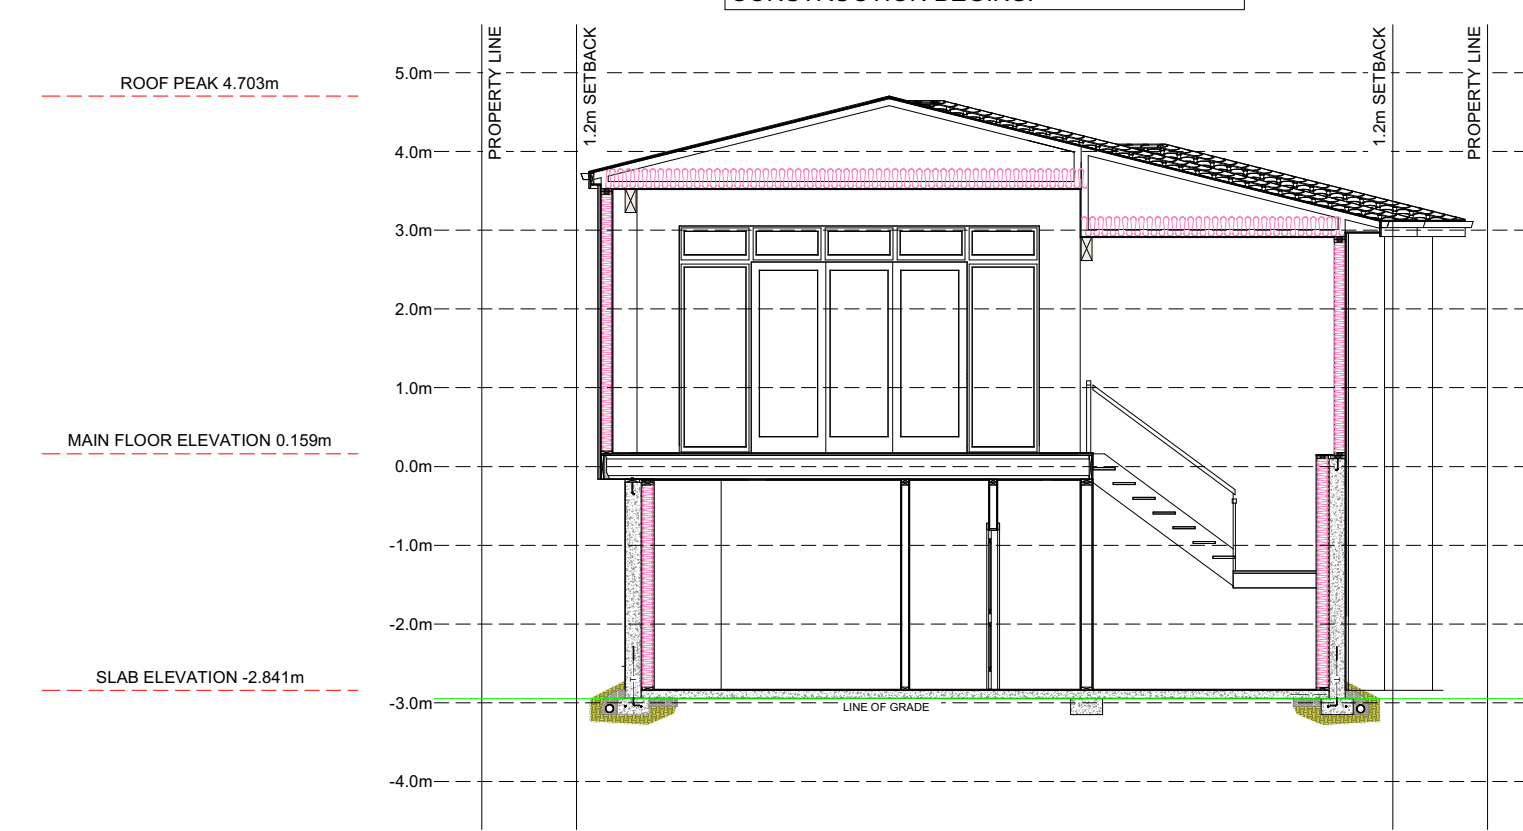

SITE SECTION B-B
SCALE: 1/8" = 1'-0"

- GRADING NOTES:**
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 3. FINAL GRADE TO CONVEY SURFACE DRAINAGE TOWARD ROCK CHANNELS AND DISPERSION TRENCHES.

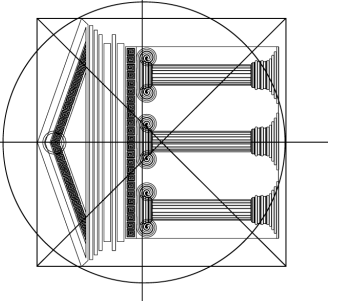

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Proposed Project For:

LOT 22 (883)
1677 HARBOUR VIEW CRES.
WEST KELOWNA
WEST HARBOUR

Sheet Title:

SITE PLAN & SITE SECTIONS

DATE:

2025-01-30

SCALE: 1/4" = 1'-0"
(UNLESS OTHERWISE NOTED)

SHEET NO.:

7/8

CODES AND STANDARDS

All workmanship is to be of a standard equal in all respects to good building practice.

At the time of preparation, this plan was drawn in accordance with the current edition of the B.C. Building Code. It is the responsibility of the owner/builder to insure that changes made to the code are complied with and all amendments are incorporated in the construction of this plan. All work shall conform to local building codes and bylaws which may take precedence.

Prior to proceeding with construction, the owner/builder must verify all information, dimensions and specifications of this plan. Written dimensions always take precedence over scale measurements.

Any variance from structural drawings and specifications or from conditions encountered at the job site, shall be resolved by the owner/builder and such solutions shall be their sole responsibility.

CONCRETE & FOOTINGS

All concrete to have a minimum compressive strength of 2,900 PSI (20 mPa) at 28 days.

Concrete footings must be placed on undisturbed or compacted soil to an elevation below frost penetration. Footings shown on these drawings have been designed for soil bearing capacity of 2,500 PSF. If a lesser bearing capacity is encountered, it is the responsibility of the owner/builder to have the footings redesigned by qualified persons to suit existing conditions.

All foundation walls 24" (600 mm) and higher should have one horizontal 10 mm reinforcing bar 3" (75 mm) from the top. Corner reinforcing to be lapped minimum 24" (600 mm).

All footings are to have two 1/2" reinforcing bars. The reinforcing bars are to be situated such that one bar is 3" (75 mm) clear of the side and bottom of the footing on both sides of the footing.

Grades shown on elevations are estimated. Adjust on site as required. Retaining walls other than the foundation walls of the residence are beyond the scope of these drawings unless otherwise noted.

INSULATION / VENTILATION

Minimum insulation requirements:

Roof/Ceiling – R 50
Walls – 2 x 6 – R 24
Garage Ceiling – R 50

Ceiling insulation may be loose fill type or batt type. Wall and floor insulation must be batt type.

Walls and ceilings between residence and attached garage shall be insulated.

Insulation requirements may vary with heating systems and with local conditions.

All roof spaces shall be ventilated with soffit, roof or gable vents or a combination of these, equally distributed between the top of the roof space and soffits.

SPECIFICATIONS

ROOF

TILE ROOFING
7/16" ROOF SHEATHING
ENGINEERED ROOF TRUSSES
R-50 INSULATION
6 MIL UV POLY
1/2" DRYWALL

SOFFIT & FASCIA

2x6 SUB FASCIA
2x8 FASCIA BOARD
VENTED SOFFITS
NON VENTED SOFFITS

EXT. WALL

STUCCO
CULTURED STONE
3/8" WALL SHEATHING
2x6 STUDS 16" o/c
R-24 BATT INSULATION
6 MIL UV POLY
1/2" DRYWALL

INT. WALL

2x4 STUDS 16" o/c
1/2" DRYWALL BOTH SIDES

FLOOR SYSTEM

3/4" T&G SHEATHING
ENGINEERED I-JOIST

STAIR CONSTRUCTION

PRE-MANUFACTURED
STAIR SYSTEM
10" TREAD + 1" NOSING
2X6 @ 18" o/c LANDINGS

DRAINAGE TILE

4" DRAIN TILE
MINIMUM 6" DRAIN ROCK
DRY SHEETING PAPER

FOUNDATION

8" CONC. FOUNDATION
10MM REBAR
R12 STYROFOAM INSULATION
8"x16" CONC. FOOTING

CONC. SLAB

4" CONC. SLAB
6 MIL UV POLY
6" COMPACTED GRAVEL

GENERAL NOTES:

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ABOVE GRADE MASONRY

All above grade masonry is to conform to the BC Building Code.

If brick veneer is to be installed, counter flashing shall be installed up to 8" (200 mm) behind the building felt and below the bottom course with vertical joints raked clean. Weep holes 24" (600 mm) o.c..

CARPENTRY

Framing lumber shall be number two (2) or better Spruce unless otherwise specified on the plan. All beam and lintel sizes shown on the drawings to be reviewed & confirmed by truss manufacturer and contractor. Any beam or lintel sizes provided by truss/floor manufacturer take precedence.

Joists are to be doubled under parallel partitions.

Joists shall be placed to accommodate plumbing, in the event of a discrepancy please contact floor supplier before any alterations or cuts are made.

Wood in contact with concrete shall be dampproofed with 45 lb. felt or a sill plate gasket and pressure treated with a waterborne preservative or other approved method on exterior walls.

Interior framing to be 4" (100 mm) clear of back and sides of firebox and 2" (50 mm) clear of brick chimneys. Frame exterior walls 1" (25 mm) clear from exterior fireplaces.

Plates are to be anchored to concrete with 1/2" anchor bolts, maximum 6 ft. o.c. or other approved method.

Flush framed wood members shall be anchored with 200 lb. joist hangers unless otherwise specified.

MISCELLANEOUS

Caulk over and around all exterior openings using non-hardening caulking compound.

Flash all changes of materials on exterior walls.

Flash over all exterior openings.


All siding or stucco to be a minimum of 8" (200 mm) above finished grade.

All balcony railings to be 3'6" (1070 mm) in height. Maximum spacing between vertical members is 4" (100 mm). Minimum distance between horizontal rails to be 32" (800 mm). Top rail to sustain outward load of 40 lbs. per lineal foot.

Coat and clothes closets shall have at least one rod and shelf with minimum depth of 24" unless otherwise stated. Linen closet shall have 5 adjustable shelves wherever possible. Broom closets shall have on shelf.

DETAIL F4


SCALE: 1" = 1'-0"

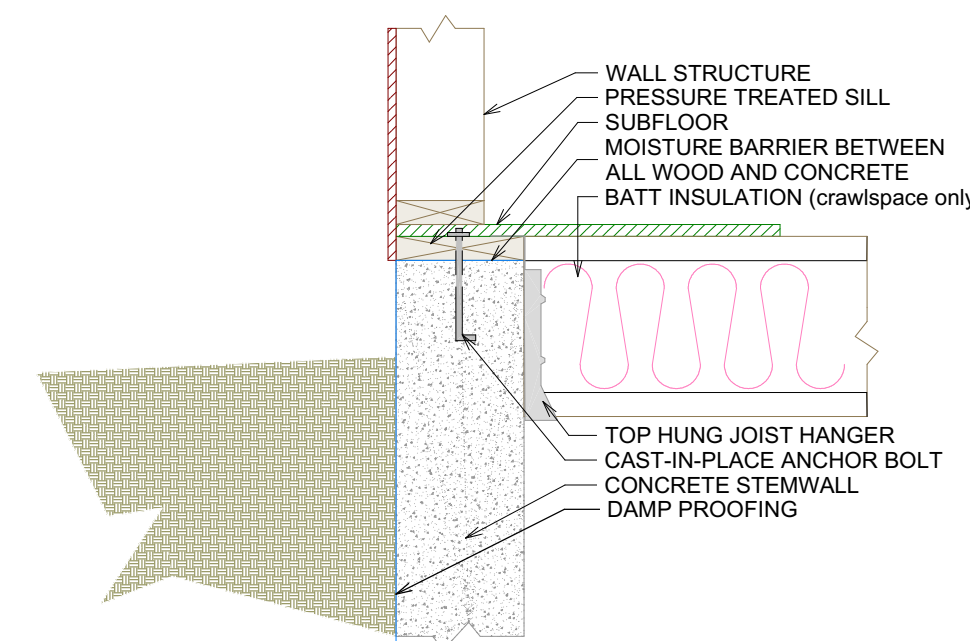

Floor at Foundation Hung From Sill Plate

DETAIL D1


SCALE: 1" = 1'-0"

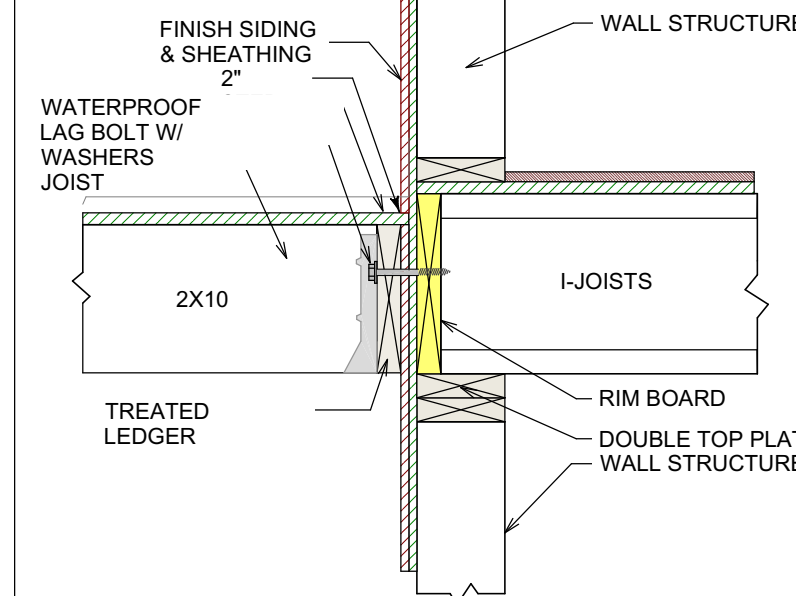

Waterproof Deck

DETAIL F1


SCALE: 1" = 1'-0"

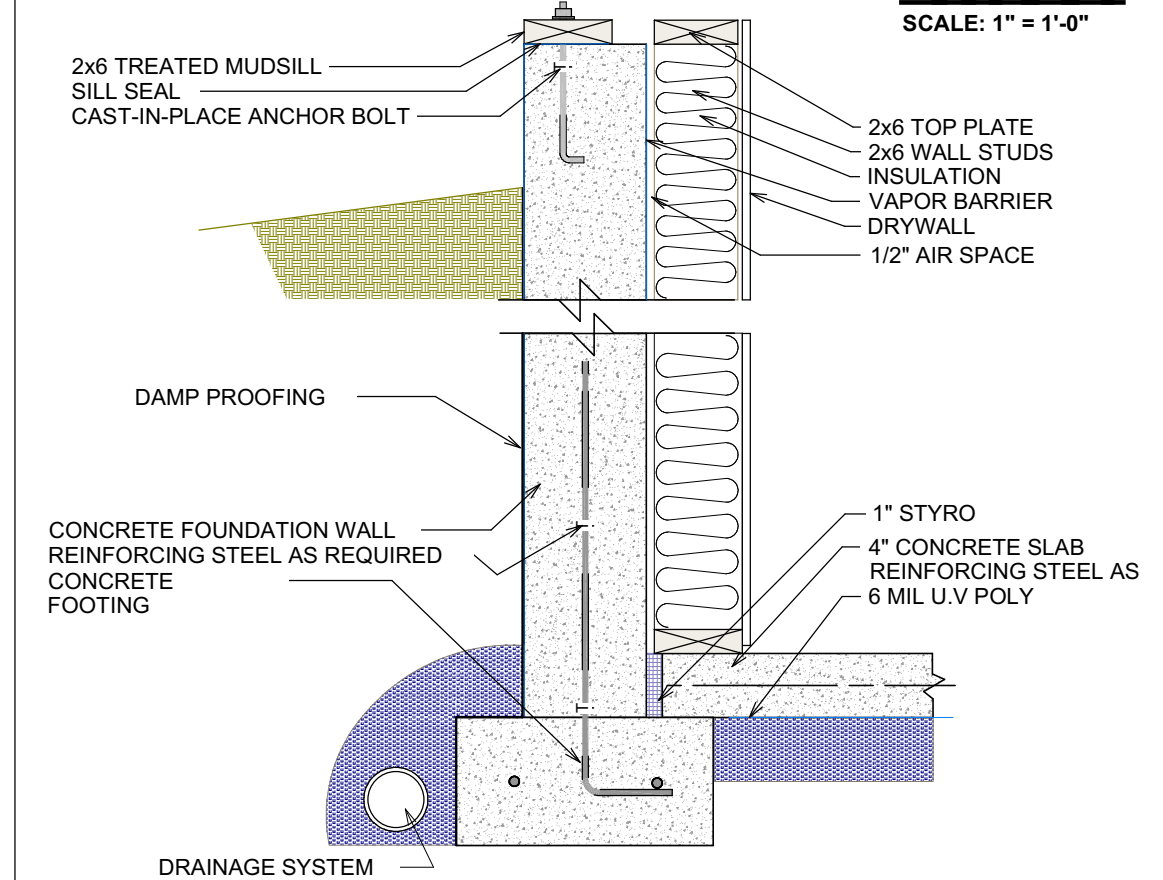

Basement Foundation: Finished 6" Wall

DETAIL F2


SCALE: 1" = 1'-0"

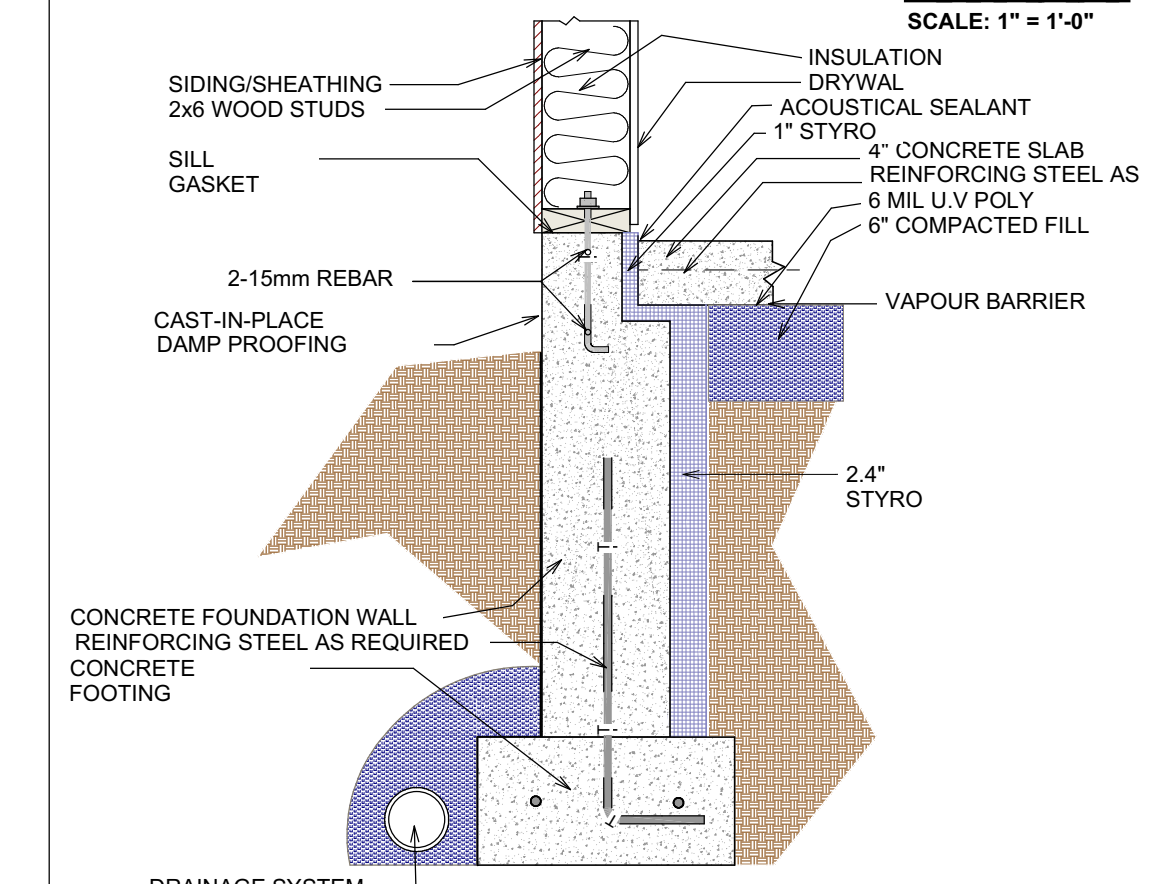

Foundation Frost Wall: 24" (Min)

DETAIL B1


SCALE: 1" = 1'-0"

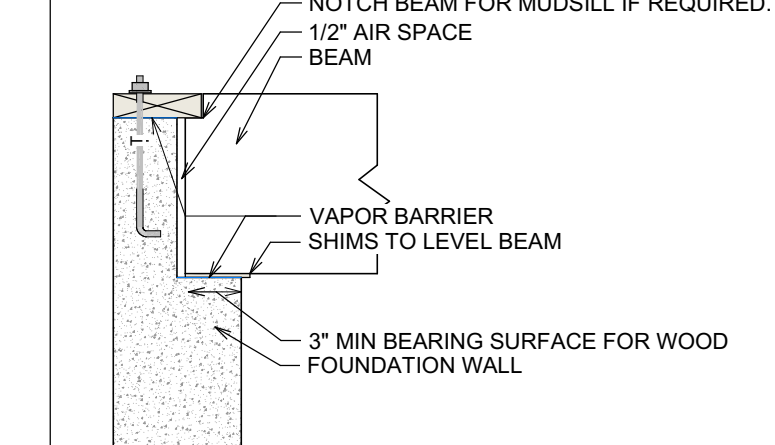

Beam Pocket

DETAIL C1


SCALE: 1" = 1'-0"

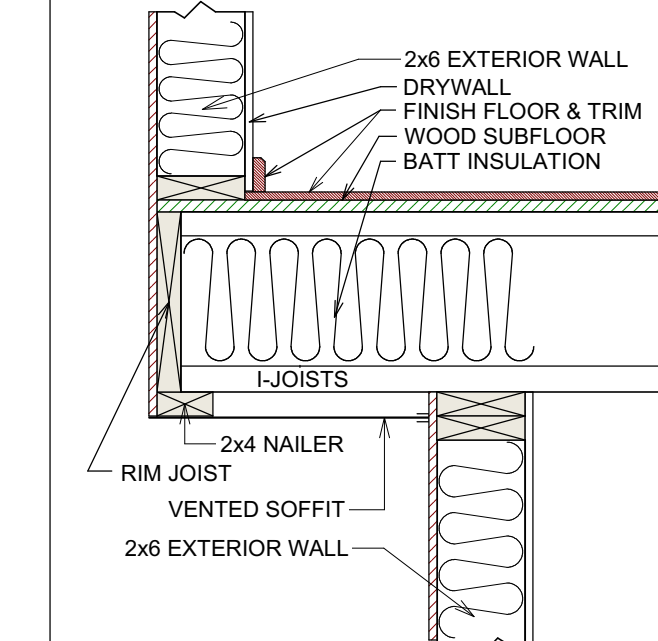

Floor Cantilever

DETAIL Q1


SCALE: 1" = 1'-0"

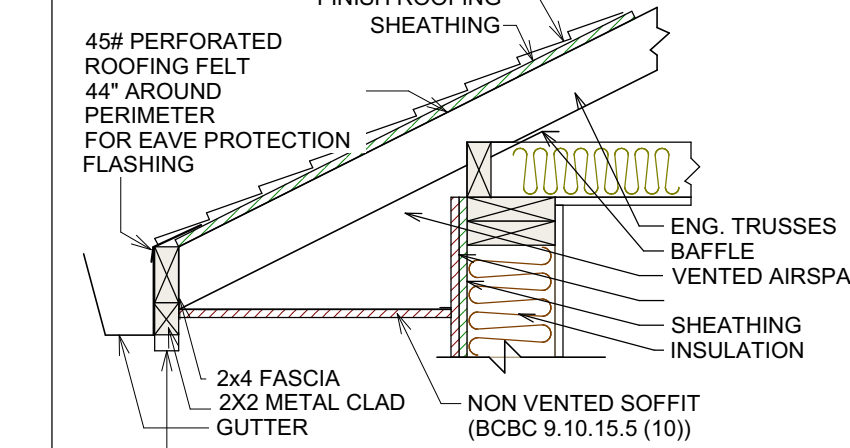

Non Vented Roof Overhang

DETAIL O1


SCALE: 1" = 1'-0"

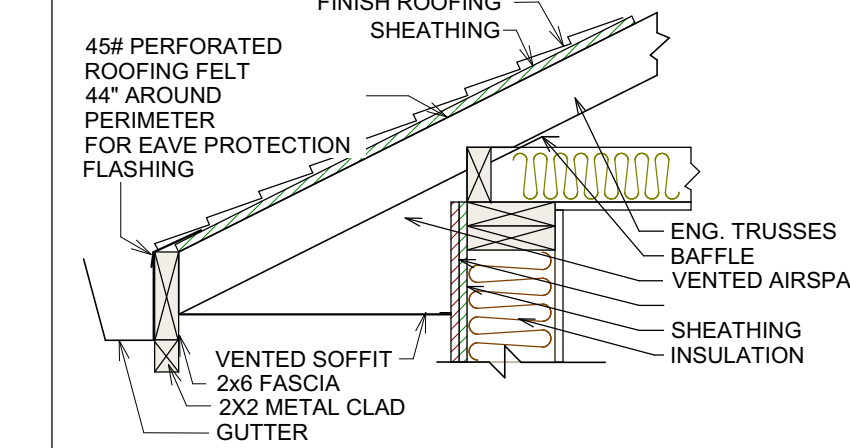

Roof Overhang

DETAIL S1

SCALE: 1" = 1'-0"

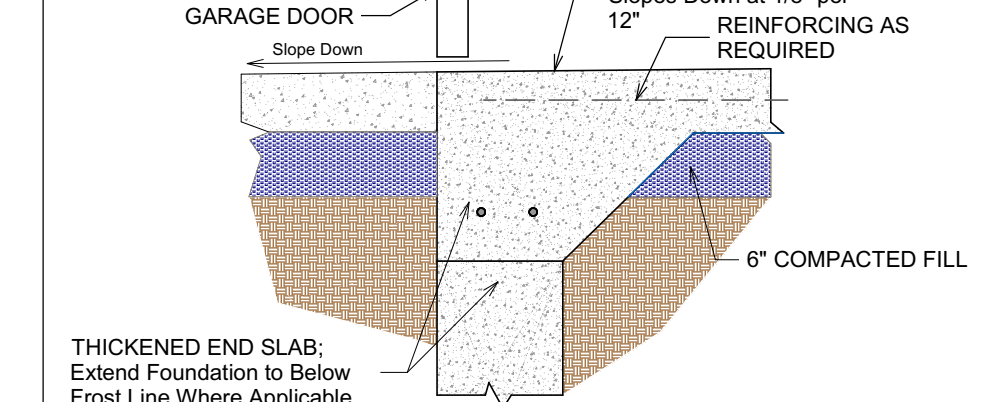


Turned Down Slab at Garage Opening

BUILDING CONTRACTOR/HOME OWNER TO REVIEW AND VERIFY ALL DIMENSIONS, SPECS. AND CONNECTIONS BEFORE CONSTRUCTION BEGINS.

WINDOW SPECIFICATIONS TO BE CONFIRMED BY CONTRACTOR/HOME OWNER PRIOR ORDERING TO ENSURE CORRECT EGRESS AND VENTING

PROVIDE PROPER SLOPE TO ALLOW DRAINAGE AWAY FROM RESIDENCE

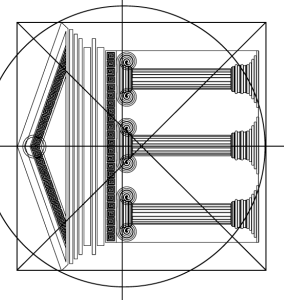

Proposed Project For:

LOT 22 (883)

1677 HARBOUR VIEW CRES.
WEST KELOWNA

WEST HARBOUR

Sheet Title:

NOTES & DETAILS

DATE:

2025-01-30

SCALE: 1/4" = 1'-0"
(UNLESS OTHERWISE NOTED)

SHEET NO.:

8/8